



**TUNDRA
ENERGY MARKETING LIMITED**

3100 – 715 5th Ave SW, Calgary, AB T2P 2X6 TEL: 403-536-0800

Ms. Stacy McBride

Petroleum Branch
Ministry of Innovation, Energy and Mines
Box 1359, 227 King Street West
Virden, Manitoba
ROM 2C0

October 5, 2015

RE: Two Creeks Lateral and LACT

Dear Ms. McBride,

Tundra Energy Marketing Limited hereby makes application under section 149 (2) of the Oil and Gas Act for a Pipeline Construction Permit for a pipeline from 03-34-12-27 to 08-16-11-26 WPM.

Documentation requested by Manitoba Innovation, Energy and Mines department for such Pipeline Construction Permit Application is included in the enclosed package.

Sincerely,

Sam Stephenson
VP, Engineering & Construction
Tundra Energy Marketing Limited

cc. Petroleum Branch, Winnipeg, MB



**An Application to
Manitoba Innovation, Energy and Mines
Petroleum Branch**

**to
Construct a New Crude Oil Pipeline**

**In the
Virден Area**

**From a new TEML LACT Facility and Elcano Battery in 03-34-12-27
To a new pipeline riser at 08-16-11-26 WPM**

**Prepared by Asher Engineering Ltd.
October 1, 2015**

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1. Introduction

Tundra Energy Marketing Limited (hereafter referred to as “TEML”) proposes to build, own, and operate a new steel pipeline to:

1. Transport crude oil from a new TEML LACT facility at an Elcano Exploration Inc (“Elcano”) battery site (03-34-12-27 W1M) to TEML’s Virden Pipeline System.

The tie-in to TEML’s Virden Pipeline System will occur at a new riser located in 08-16-11-26 W1M. This riser site will facilitate pigging of the Two Creeks Pipeline and the connection to the existing SC-03 pipeline.

In accordance with Section 149(2) of the Oil and Gas Act, TEML hereby makes application to Manitoba Innovation, Energy and Mines - Petroleum Branch, for approval of a pipeline construction permit.

2. Applicant Information

The pipeline (hereafter referred to as the “Two Creeks Pipeline”) will be owned and operated by TEML which is a wholly-owned subsidiary of Winnipeg-based James Richardson & Sons, Limited (“JRSL”). JRSL is a multi-disciplined enterprise with operations in agriculture, food processing, financial services, property management and energy exploration in Manitoba and the prairies.

TEML is experienced in the operation of similar oil pipelines. The proposed pipelines will be operated out of TEML’s Cromer field office.

The pipeline will be designed by Asher Engineering Ltd. Asher has been in the consulting engineering business since 1993, is licensed to practice engineering in Manitoba, and has specific experience with the design of these types of pipelines.

3. Overview of the Application

This application is for a new steel pipeline as detailed below:

1. A 168 mm OD (NPS6) steel pipeline, approximately 20 km in length, from a new TEML LACT facility (and Elcano Battery) at 03-34-12-27 W1M to a new TEML riser site in 08-16-11-26 W1M.

The new pipeline will be constructed in a 20 m Right of Way (RoW) and environmental disturbance will be minimized wherever practical.

The below have been included with this application; in accordance with the requirements of Manitoba Petroleum Guideline 1:

- a) A System Map (provided in Appendix A) indicating the Elcano Battery, entire pipeline route, land topography, etc.

A survey showing additional details along the route, such as crossings and nearby facilities, can be found in Appendix B.

As the pipeline does not require any major water crossings, valves for isolating the line are only required at the endpoints. These valve locations are shown on the plot plans in Appendix C.

- b) The location of all towns or cities, highways and water covered areas are shown in the maps and drawings included in Appendices A and B.

There are no tanks associated with this project application.

- c) Typical profile and cross section drawings for this project are included in Appendix D. These include road, waterway and pipeline or utility crossings.

- d) Survey information of the site for the LACT facility and surrounding area are included in Appendices B and C.

- e) A plot plan for the Elcano 03-34 Battery is included in Appendix C.

- f) A Process Flow Diagram (PFD) indicating the proposed pipeline tie-ins at the 03-34 Elcano Battery and the new TEML 08-16 pipeline riser are included in Appendix E.

- g) A shape or DXF file of the proposed pipeline route is enclosed.

4. Intended Use and Need

The new NPS 6 pipeline will eliminate the need for trucking oil volumes and will decrease risks associated with truck traffic on local roadways. Additional benefits include uninterrupted oil delivery due to road bans or poor road conditions, and reduced wear and tear on local roads. The Two Creeks Pipeline will deliver oil from Elcano's Battery in 03-34 to TEML's Virden Pipeline System, and ultimately CTT for storing, processing and transmission to refineries.

5. Pipeline and LACT Description

- a) The pipeline will run from 03-34-12-27 to 08-16-11-26 W1M.
- b) The pipeline will transport LVP crude oil.
- c) The pipeline length is expected to be approximately 20km.
- d) The new pipeline will be 168.3mm OD; the wall thickness of the pipe, pipe grade and additional information is tabled in Appendix F.
- e) Corrosion Control: The steel pipeline will be externally coated with an extruded polyethylene coating. Pipeline girth welds will be protected by compatible shrink type sleeves. The pipelines will be cathodically protected using an impressed current system to provide additional external corrosion control. Test stations will be installed at end points and at foreign crossings where required by agreement with the foreign pipeline owner. Upon completion of construction and as part of a routine maintenance program the pipelines will be batch filmed with corrosion inhibitor. Corrosion inhibitor will also be continuously injected into the product stream and monitored as part of an integrity management plan. Corrosion monitoring spools (“fish bellies”) will be installed as a part of the TEML piping (at the Elcano 03-34 battery) to allow routine ultrasonic inspection for corrosion monitoring. The pipelines will be routinely pigged to remove water and / or sediment that may collect in low areas. The design of the pipelines will include pigging facilities and long radius risers that will accommodate the use of smart pig technology to monitor the pipeline condition. The corrosion control system will comply with Clause 9.0 of CSA Z662-15.

Spill Risk Mitigation: Product will be gravity fed from Elcano storage tanks to the TEML LACT package. The LACT package will include a booster pump, basket strainer, water cut monitor, oil sampler, meters and a shipping pump. The LACT package will also be equipped with Motor Operated Valves (“MOVs”) for shutdown purposes. These MOVs will be actuated by signals from the facility PLC and/or SCADA system. Coriolis meters will provide custody transfer measurement of oil from Elcano’s storage tanks into the Two Creeks Pipeline.

Leak detection will be managed by TEML’s existing computational leak detection system, and will be done on a system-wide basis. Alarms will be triggered in the event of a leak, and TEML operators will be responsible for closing the MOVs.

Operators will receive alarms to issue a shutdown should the pressure of the pipeline deviate above or below the set pressures.

Expected Daily Flow: The Two Creeks Pipeline is expected to carry flow rates of up to 2000 m³/day. This rate may vary with future volumes and production rates.

Terminal Storage Capacity: No additional oil storage is proposed at the terminal in connection with this application.

- f) The design pressure and the maximum operating pressure that the pipeline is expected to be qualified to by pressure testing is included in Appendix F.
- g) Material specifications and standards for the pipe, valves, flanges and other fittings for the pipeline are included in Appendix F.
- h) No process vessels are a part of this application.
- i) This is a liquid pipeline and as such, in the unlikely event of a pipeline rupture, the spill would not result in significant vapor dispersion.

6. Proof of Consultation and Access

The following confidential information is contained in the Line List, included in this document as Appendix G:

- a) The names and addresses of all landowners, occupants and residents, complete with land location, within the following areas:
 - i) 1.5 km radius of each endpoint of the pipeline and
 - ii) a radius of 0.5 km along the length of the proposed line.
- b) A copy of the notice and proof of consultation with all parties listed in 6.a above.
- c) A description of the applicant's consultations with all parties listed in 6.a above including a summary of any concerns raised during the consultation process and all actions taken or proposed to be taken by the applicant to address concerns, and
- d) Proof of the right to access the proposed surface RoW.

7. Environmental Protection Plan

TEML will follow an Environmental Protection Plan (EPP) for planning, designing, construction and post-construction purposes. This plan is being developed by Matrix Solutions Inc. and will be submitted for review as a supplement to this document.

TEML will use a corporate level Emergency Response Plan (ERP) which is intended to handle any emergency situations that may arise. Tundra's emergency

telephone number is 1-844-333-6789. This number is attended 24 hours a day, 7 days a week. The ERP will be amended to include the new pipelines.

8. Other Approvals

- a) **Municipalities**
Notifications and discussions regarding crossing agreements and zoning requirements with the R.M. of Wallace are being undertaken simultaneous to this application.
- b) **Urban Municipality**
The pipeline is not located within 1.5 km of an urban municipality.
- c) **Historic Resources Branch**
Matrix Solutions has completed an environmental pre-development assessment of the proposed pipeline. Screening results by the Manitoba Historic Resources Branch indicate that no previously recorded heritage sites have been identified and the potential of the pipeline to impact significant heritage resources is considered low.
- d) **Manitoba Infrastructure and Transportation**
Notifications and discussions regarding crossing agreements are being undertaken with Manitoba Infrastructure and Transportation simultaneous to this application.
- e) **Railway Crossings**
There are no railway crossings associated with this project.
- f) **Waterway Crossings**
There are no major water crossings associated with this project.
- g) **Utility or Foreign Pipeline Crossings**
Utilities and foreign pipeline companies are being notified of the proposed pipelines and crossing agreements are being obtained simultaneous to this application.
- h) **Surface Landowners**
All surface landowners have been notified of the proposed project and agreements are being obtained.
- i) **Indian Bands**
There are no First Nations, Métis Communities or other Aboriginal communities in the area of the proposed pipeline.
- j) **SC-03 Pipeline Modification**

The existing TEML SC-03 pipeline will need a modification approval for the tie-in of the Two Creeks Pipeline. This application will be drafted and submitted to the Manitoba Petroleum Branch under separate cover.

9. Environmental Licence

As the proposed NPS 6 pipeline is longer than 10km in length, an Environmental License will be required. In preparation for application to the Manitoba Environmental Approvals Branch (EAB), an Environmental Pre-Development Assessment (EPDA) is being prepared by Matrix Solutions Inc. A copy of this assessment will be submitted for review as a supplement to this document. The EAB has been notified of the project, and an Environment Act Proposal (EAP) will be submitted for review in the immediate future.

10. Initial Aboriginal Consultation Assessment



An Initial Aboriginal Consultation Assessment is being sent to Mr. Keith Lowdon, Director of the Petroleum Branch.

Appendix A

System Map

Appendix B

Survey Plans

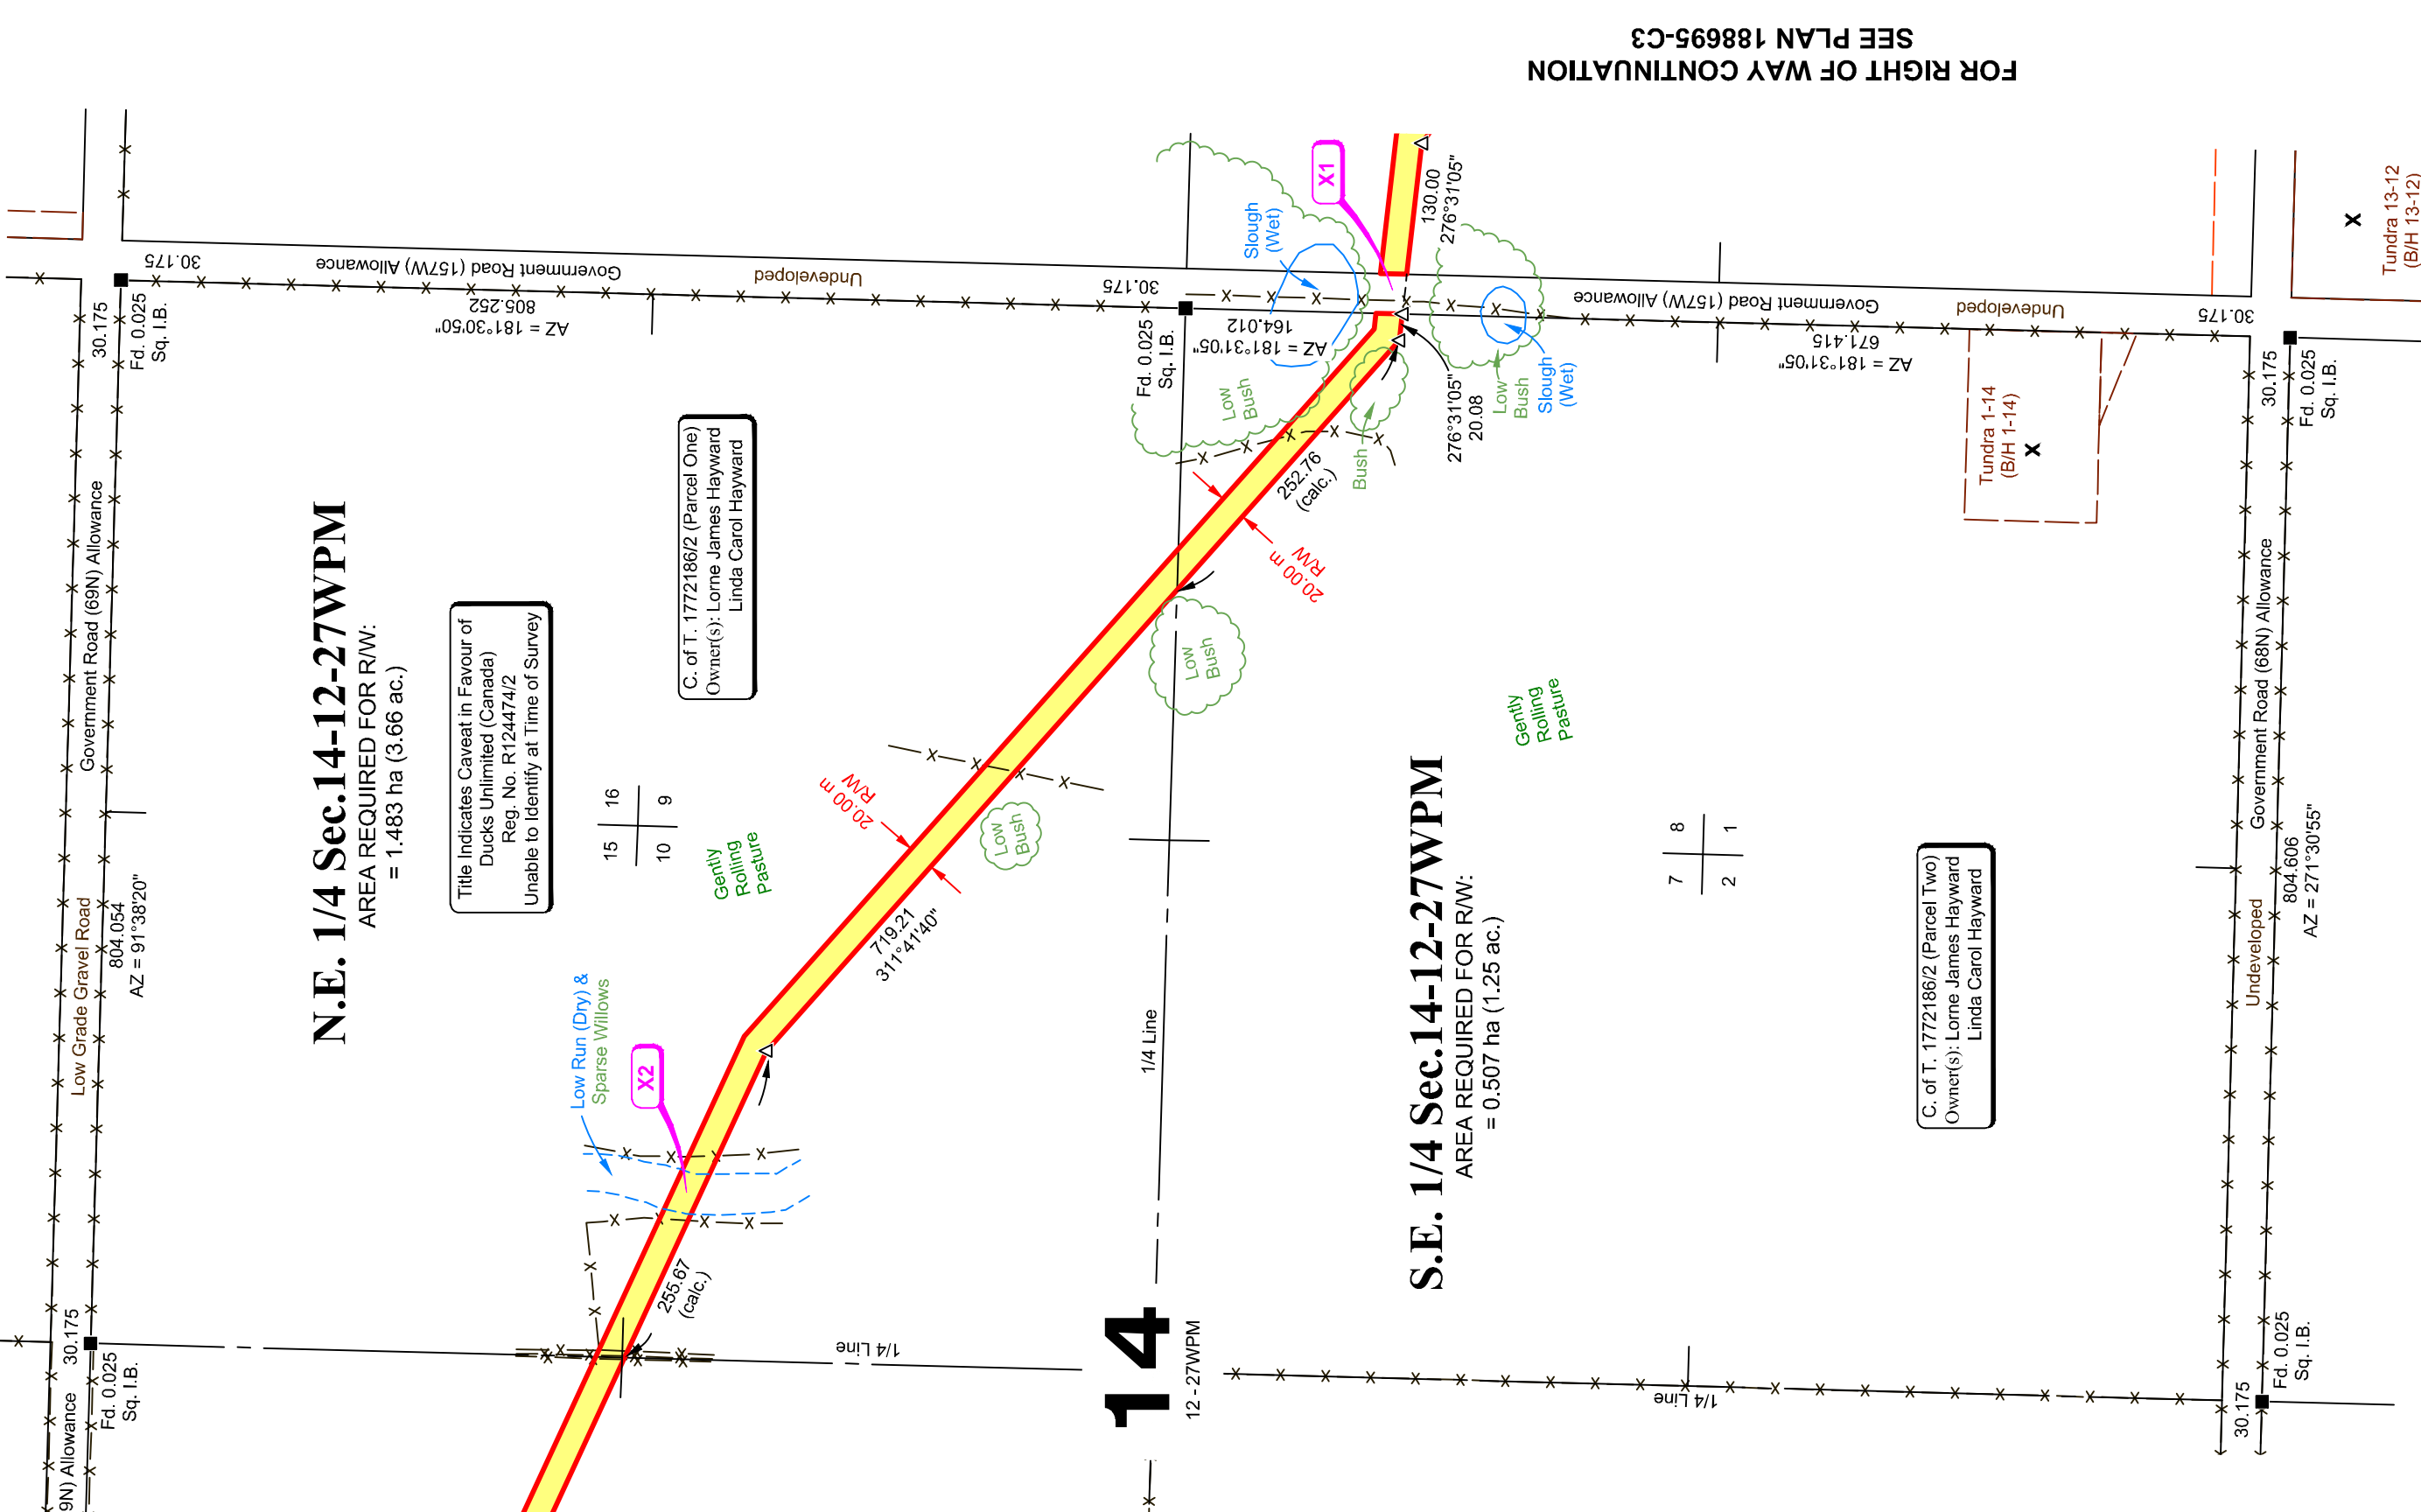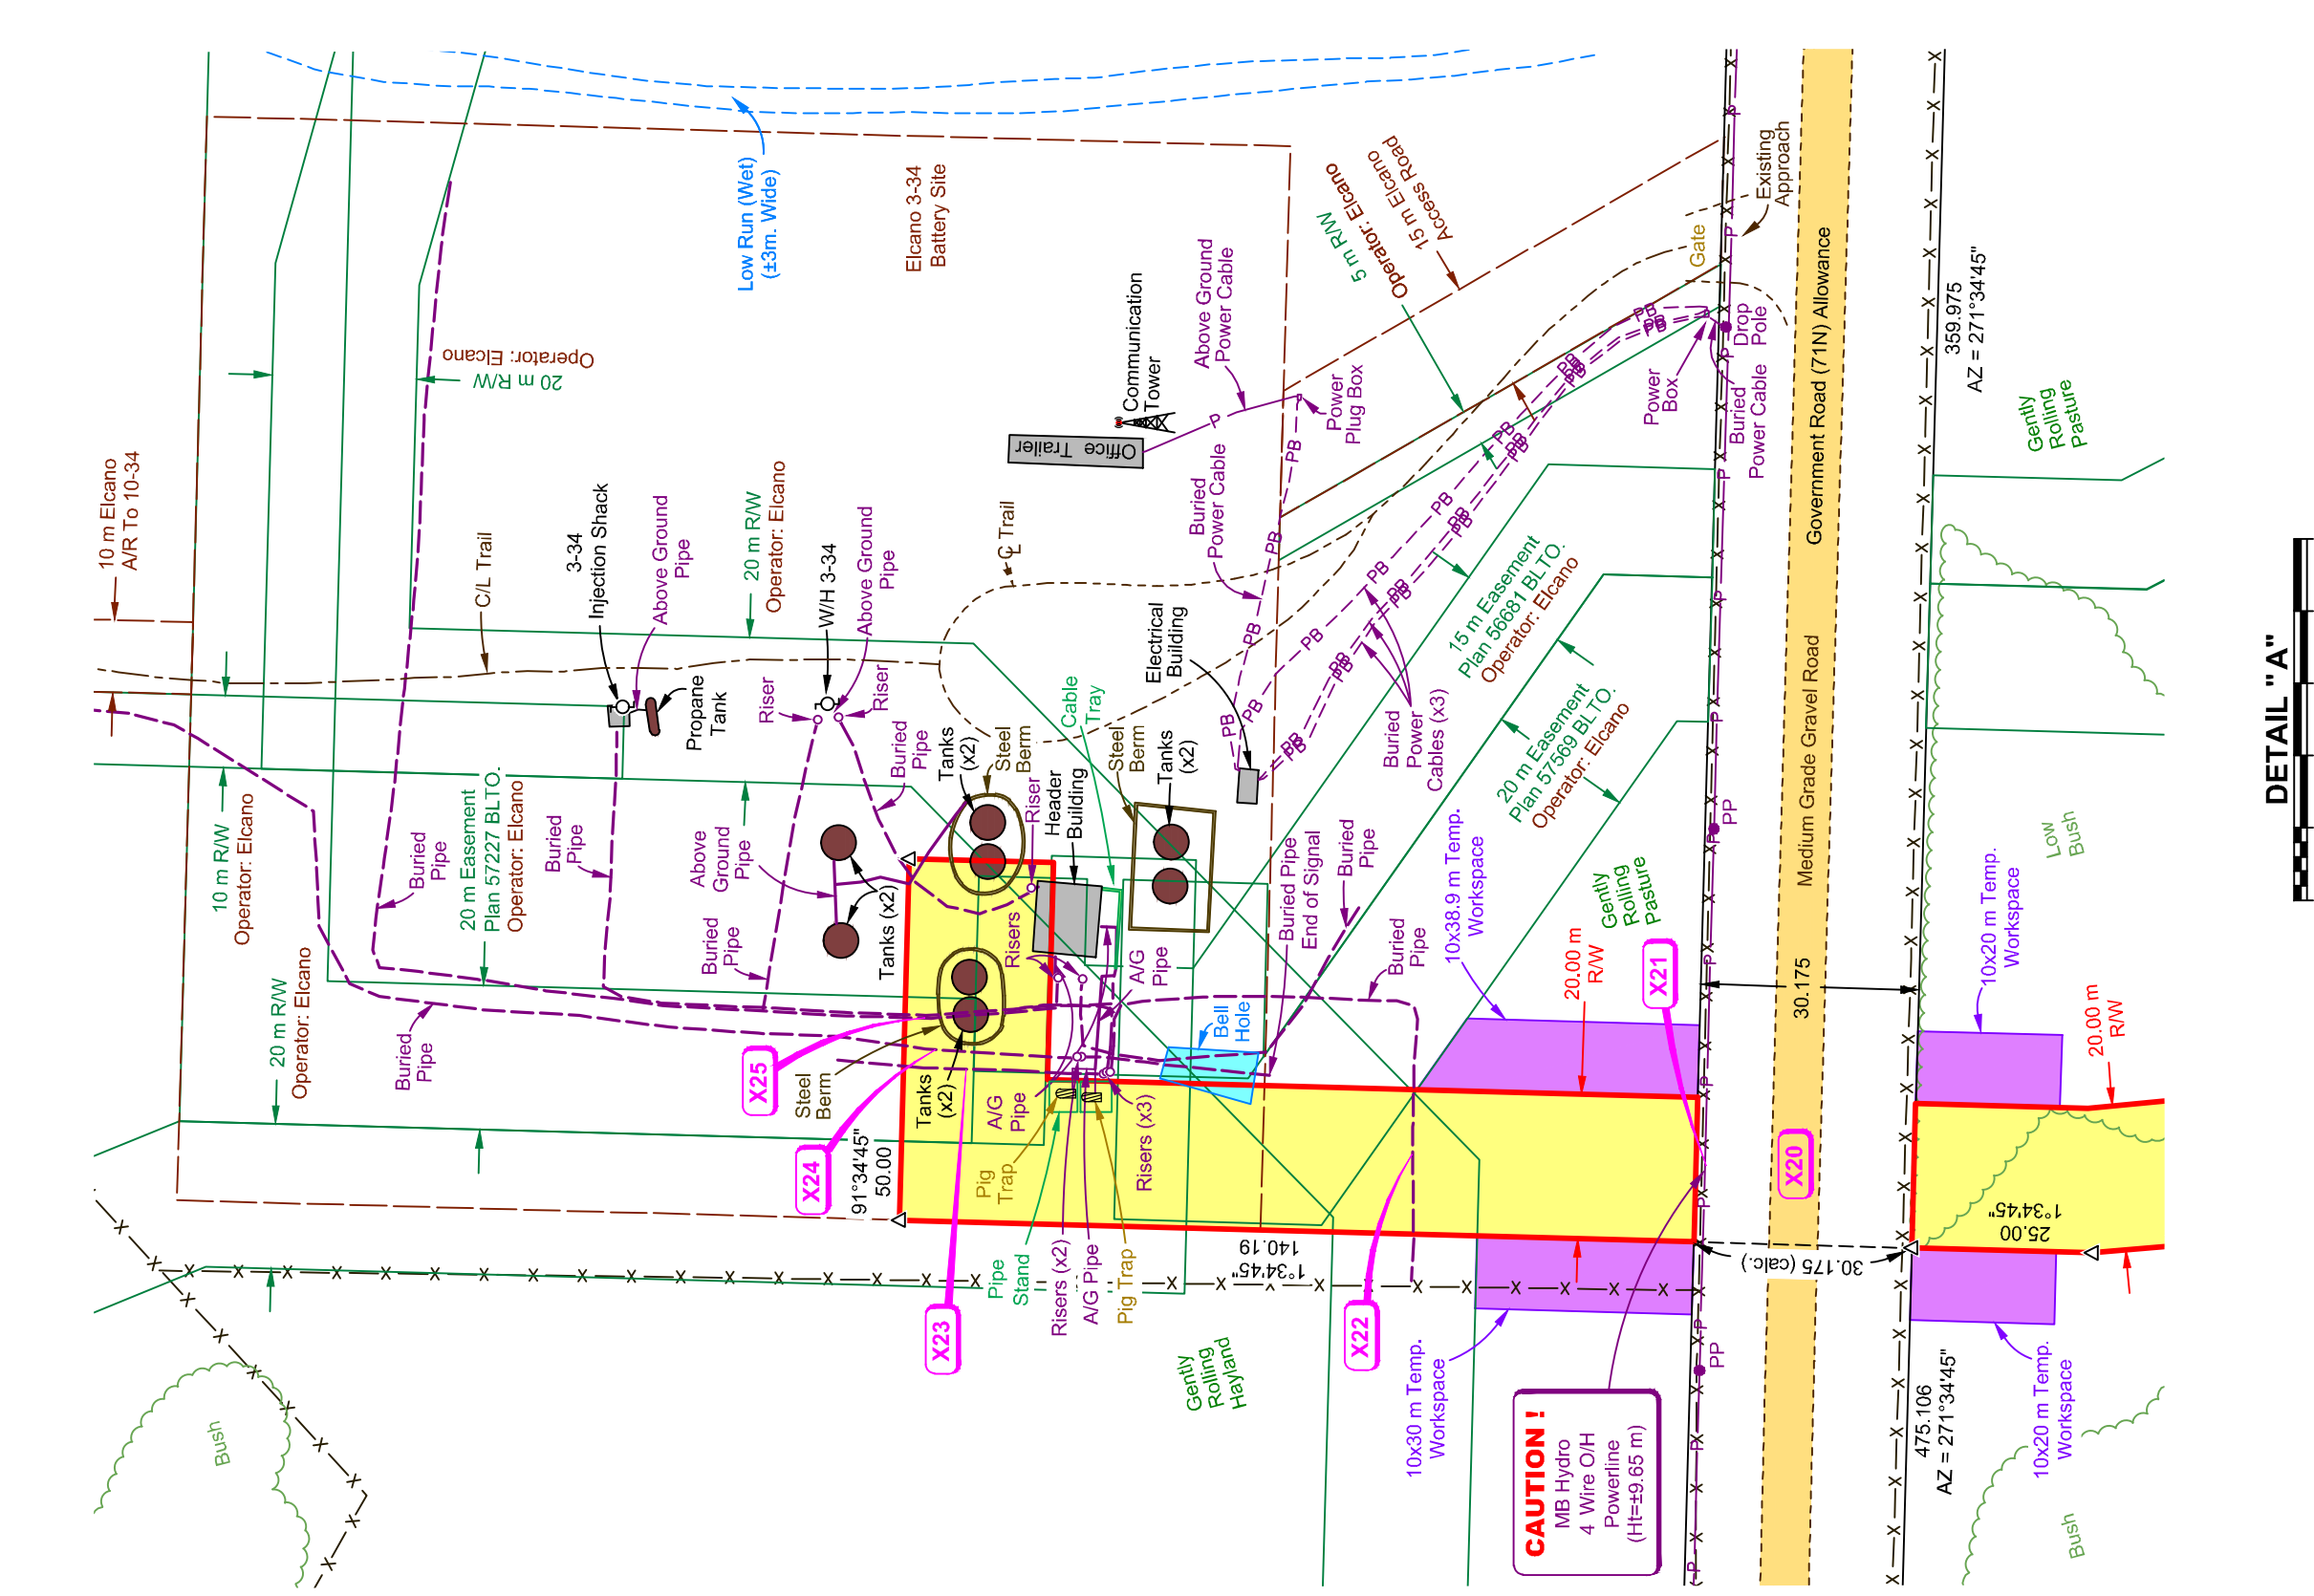

MLS AFFIDAVIT

I certify that the survey represented by this plan is correct to the best of my knowledge.

OPERATOR: TUNDRA ENERGY MARKETING LTD.

B. J. Kelly
Municipal Land Surveyor

CROSSING TABLE

Drawing No.	Description	Status	Location
X1	30.175 Government Road (157M) Advance - Unimproved	Issued Plan 7	Between SW 1/4 & SE 1/4 12-27WPM
X2	Low Rail (Dry)	Not To Be Issued	NE 1/4 12-27WPM
X3	30.175 Government Road (159M) Advance - Low Grade Gravel Road	Issued Plan 7	Between NW 1/4 & SW 1/4 12-27WPM
X4	25 m RW - Operator Easement (Buried Power Cable)	Issued Plan 7	SW 1/4 12-27WPM
X5	25 m RW - Operator Easement (Buried Power Cable)	Issued Plan 7	SW 1/4 12-27WPM
X6	Low Rail (Dry)	Not To Be Issued	SW 1/4 12-27WPM
X7	25 m RW - Operator Easement (Buried Power Cable)	Issued Plan 7	SW 1/4 12-27WPM
X8	25 m RW - Operator Easement (Buried Power Cable)	Issued Plan 7	SW 1/4 12-27WPM
X9	4 Wire Overhead Power Line - Operator Easement (Buried Pipe)	Issued Plan 7	Between NE 2/4 & SW 1/4 12-27WPM
X10	30.175 Government Road (159M) Advance - Medium Grade Gravel Road	Issued Plan 7	Between NE 2/4 & SW 1/4 12-27WPM
X11	15 m Easement "W" Plan 5524 B/L TO - Operator Easement (Not Constructed)	Issued Plan 7	NE 2/4 12-27WPM
X12	15 m Easement "W" Plan 5524 B/L TO - Operator Easement (Not Constructed)	Issued Plan 7	NE 2/4 12-27WPM
X13	15 m Easement "W" Plan 5524 B/L TO - Operator Easement (Not Constructed)	Issued Plan 7	NE 2/4 12-27WPM
X14	15 m Easement "W" Plan 5524 B/L TO - Operator Easement (Not Constructed)	Issued Plan 7	NE 2/4 12-27WPM
X15	30.175 Government Road (159M) Advance - Medium Grade Gravel Road	Issued Plan 7	Between SE 2/4 & NE 2/4 12-27WPM
X16	4 Wire Overhead Power Line - Operator Easement (Buried Pipe)	Issued Plan 7	Between SE 2/4 & NE 2/4 12-27WPM
X17	25 m Easement "W" Plan 5524 B/L TO - Operator Easement (Buried Pipe)	Issued Plan 7	SW 1/4 12-27WPM
X18	Low Rail (Dry)	Not To Be Issued	SW 1/4 12-27WPM
X19	25 m Easement Plan 5721 B/L TO - Operator Easement (Not Constructed)	Issued Plan 7	NW 2/4 12-27WPM
X20	30.175 Government Road (159M) Advance - Medium Grade Gravel Road	Issued Plan 7	Between NW 2/4 & SW 1/4 12-27WPM
X21	4 Wire Overhead Power Line - Operator Easement (Buried Pipe)	Issued Plan 7	Between NW 2/4 & SW 1/4 12-27WPM
X22	25 m RW - Operator Easement (Buried Pipe)	Issued Plan 7	SW 1/4 12-27WPM
X23	Buried Pipe - Operator Easement	Issued Plan 7	SW 1/4 12-27WPM
X24	Buried Pipe - Operator Easement	Issued Plan 7	SW 1/4 12-27WPM
X25	Buried Pipe - Operator Easement	Issued Plan 7	SW 1/4 12-27WPM

* The revision stated in the Status column refers to the Construction Plan revision.

Total length of right-of-way along posted boundary : 5.95 km
Crossings associated with this drawing : 25
Crossing plans required : 22
(Crossing plans issued for bridge crossings only)

LEGEND

Found Wooden Hub / Deflection Point shown thus ———— Δ

Found Survey Monuments shown thus ———— ■

Right - of - Way boundary shown thus ————

NOTES

- All Marker Posts placed are 0.3 metres inside the GRA unless shown otherwise
- Right-of-way to be filed is 20.00 metres perpendicular width throughout unless shown otherwise.
- All monuments are grid and are referred to UTM projection, NAD 83 (Zone 14) datum and are derived by G.N.S.S.

DISCLAIMER

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TUNDRA ENERGY MARKETING LTD.

CONSTRUCTION PLAN
of
RIGHT-OF-WAY
Within
E. 1/2 & N.W. 1/4 Sec. 14
W. 1/2 Sec. 23
N.E. 1/4 Sec. 27
S. 1/2 & N.W. 1/4 Sec. 27
&
S.W. 1/4 Sec. 34
Twp. 12 - Rge. 27WPM

North Hargrave Area
Rural Municipality of Wallace-Woodworth
2015


Scale: 1:5000

0 50 100 200 300 400 500m

AFE No.:
Client File No.:
REV: File: 18869SP-C4
Survey Date: August 26, 2015 To Sept. 10, 2015

Altus Geomatics
18869SP-C4

FOR RIGHT OF WAY CONTINUATION
SEE PLAN 18895-C4

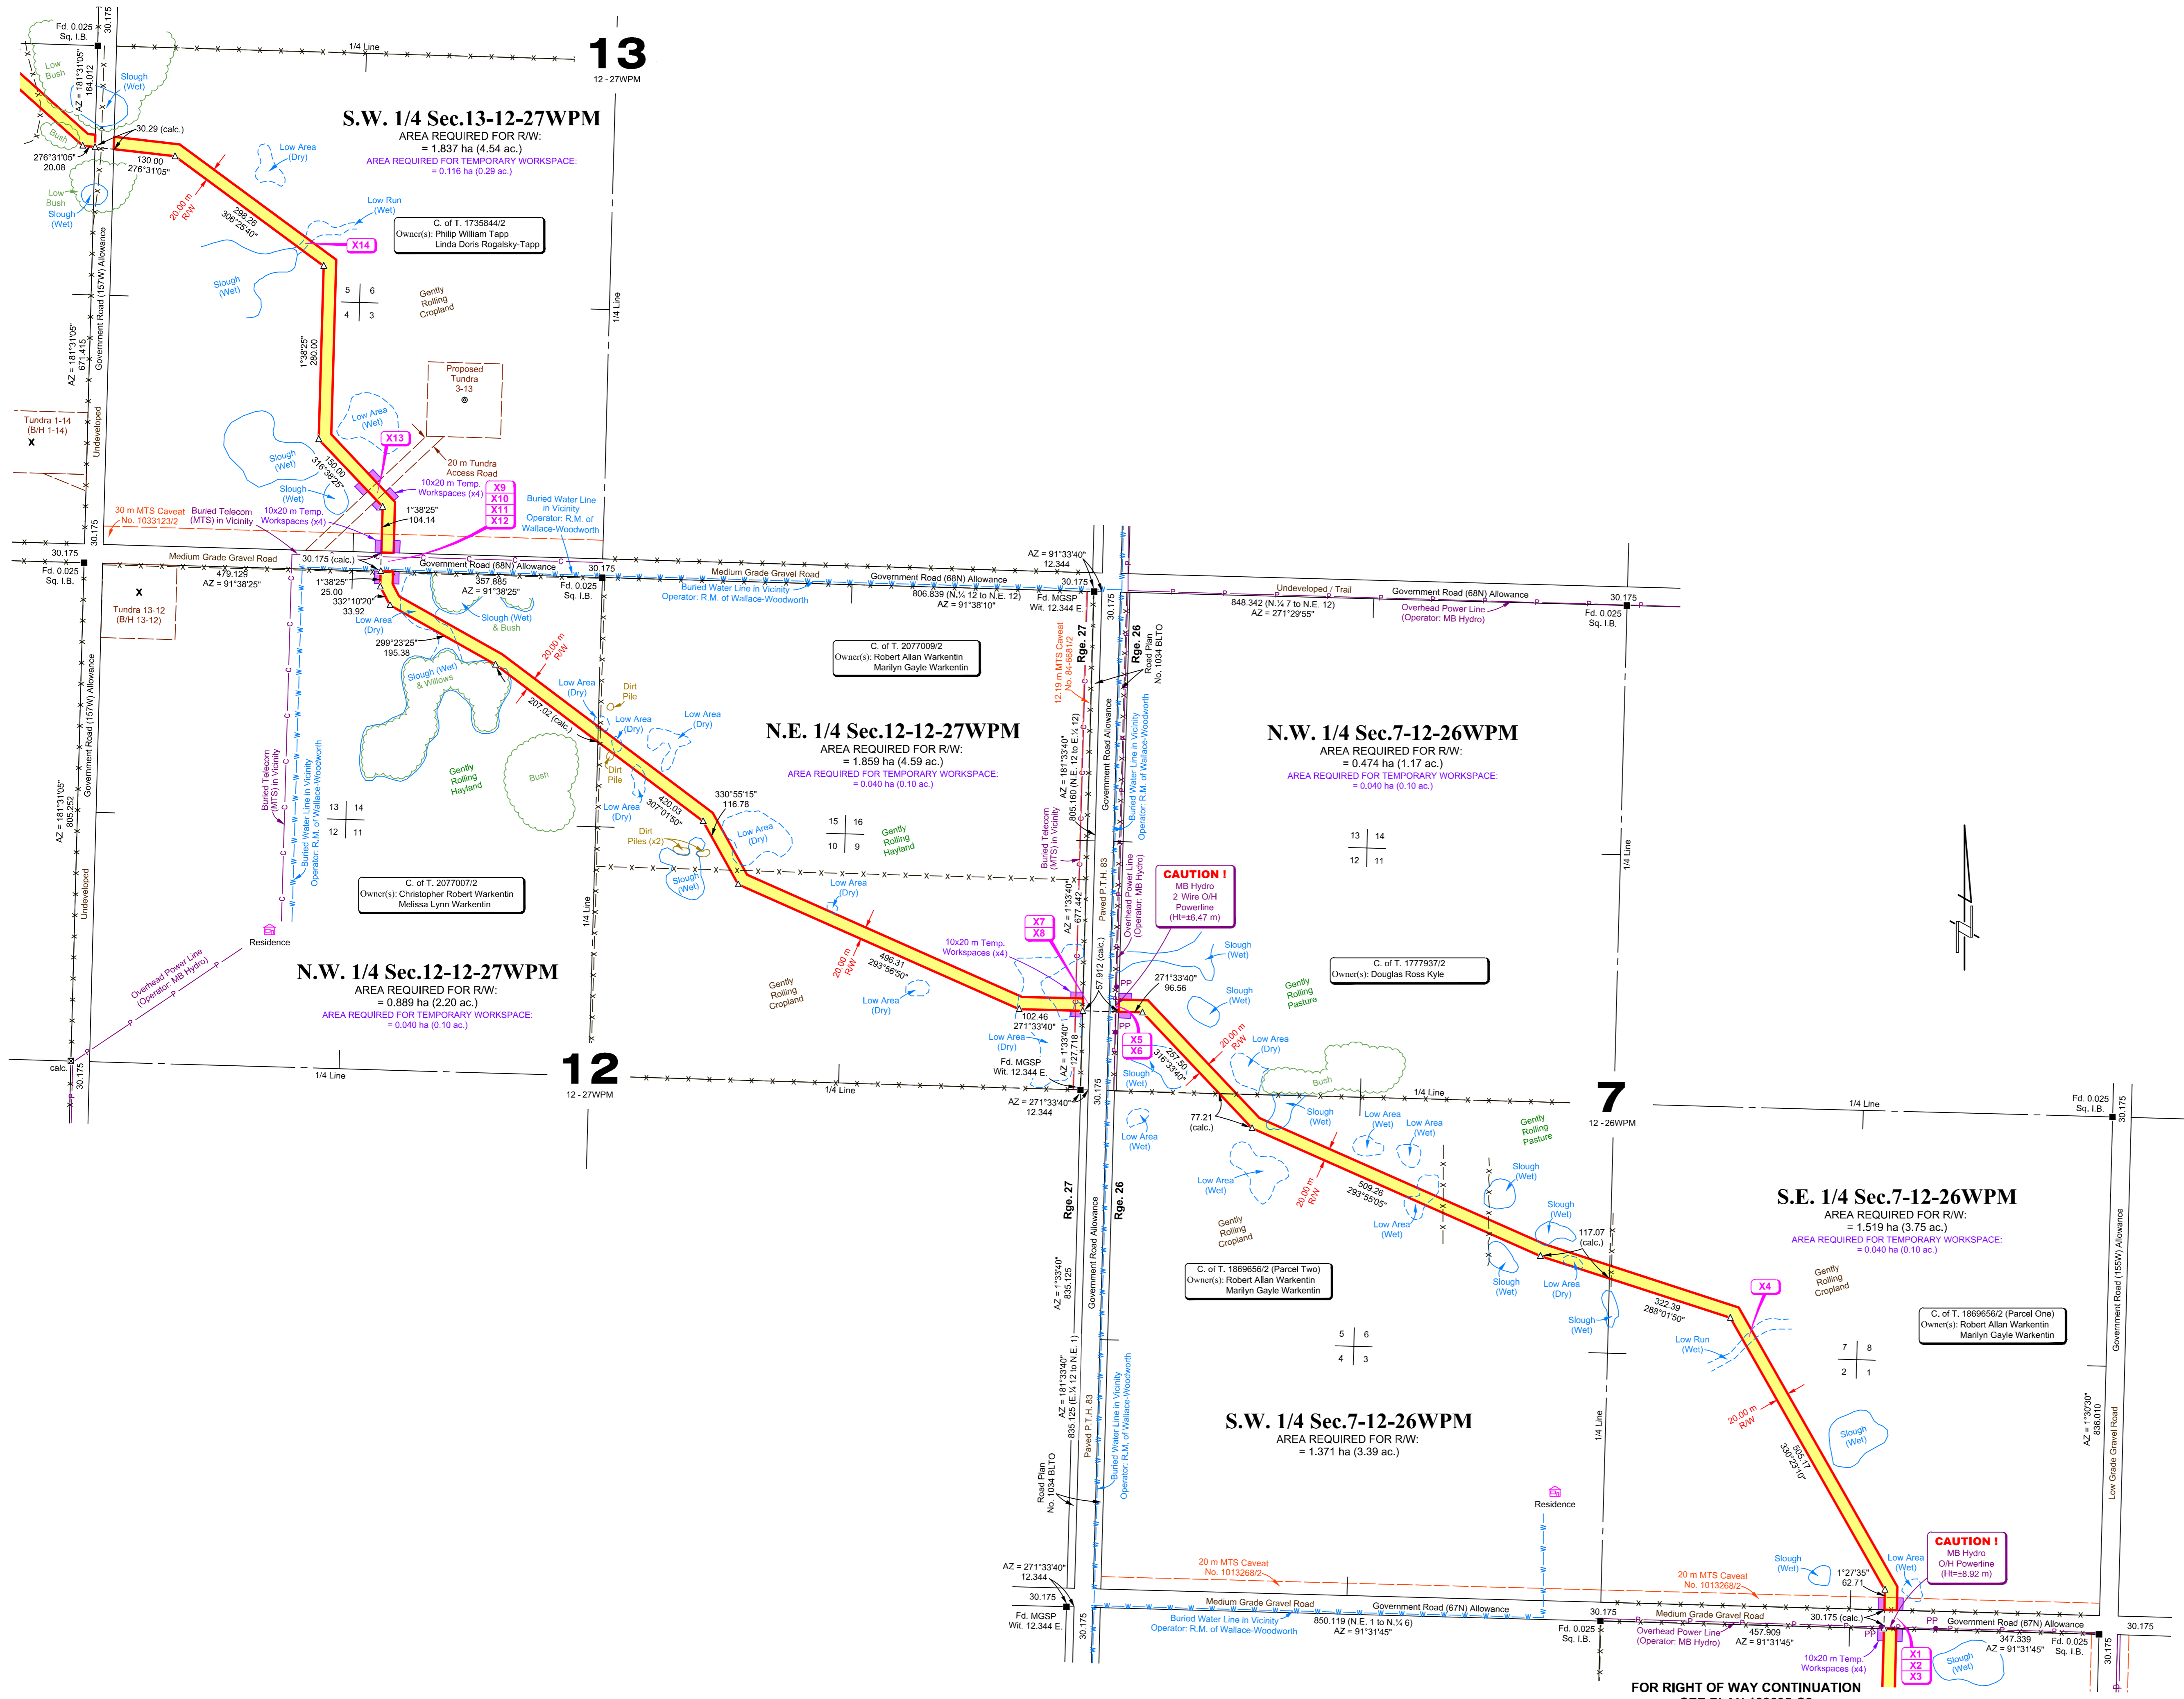

MLS AFFIDAVIT

I certify that the survey represented by this plan is correct to the best of my knowledge.

OPERATOR:
TUNDRA ENERGY MARKETING LTD.

K. Todd Kelly
Manitoba Land Surveyor

[Signature]
Witness

CROSSING TABLE

Drawing No.	Description	Status	Location
X1	Overhead Power Line - Operator: MB Hydro	Issued Rev.0	Between NE 6 & SE 7-12-26WPM
X2	30.175 Government Road (67N) Allowance - Medium Grade Gravel Road	Issued Rev.0	Between NE 6 & SE 7-12-26WPM
X3	20 m MTS Caveset No. 1013268/2	Issued Rev.0	SE 7-12-26WPM
X4	Low Run (Wet)	Not To Be Issued	SE 7-12-26WPM
X5	2-Wire Overhead Power Line - Operator: MB Hydro	Issued Rev.0	NW 7-12-26WPM
X6	Buried Water Line - Operator: R.M. of Wallace-Woodworth	Issued Rev.0	NW 7-12-26WPM
X7	P.T.I. No. 83 - Road Plan 1034 BLTO - Paved Road	Issued Rev.0	Between NW 7-12-26WPM & NE 12-12-27WPM
X8	12.19m MTS Caveset No. 84-4681/2 (Buried Telecom Cable)	Issued Rev.0	NE 12-12-27WPM
X9	Buried Water Line - Operator: R.M. of Wallace-Woodworth	Issued Rev.0	Between NW 12 & SW 13-12-27WPM
X10	30.175 Government Road (68N) Allowance - Medium Grade Gravel Road	Issued Rev.0	Between NW 12 & SW 13-12-27WPM
X11	Buried Telecom Cable - Operator: MTS	Issued Rev.0	Between NW 12 & SW 13-12-27WPM
X12	30 m MTS Caveset No. 1033123/2	Issued Rev.0	SW 13-12-27WPM
X13	20 m Tundra Access Road (Proposed)	Issued Rev.0	SW 13-12-27WPM
X14	Low Run (Wet)	Not To Be Issued	SW 13-12-27WPM

* The revision stated in the Status column refers to the Construction Plan revision.

Total length of right-of-way along posted boundary : 4.11 km
 Crossings associated with this drawing: 14
 Crossings plans required : 12
 (Crossing plans issued for foreign crossings only)

LEGEND

Placed Wooden Hub / Deflection Point shown thus:

Found Survey Monuments shown thus:

Right - of - Way boundary shown thus:

NOTES

- All Marker Posts placed are 0.3 metres inside the GRA unless shown otherwise
- Right-of-way to be filed is 20.00 metres in perpendicular width throughout unless shown otherwise.
- Azimuths are grid and are referred to UTM projection, NAD 83 (Zone 14) datum and are derived by G.N.S.S.

DISCLAIMER:

This plan represents the best information available at the time of survey. Altus Geomatics Manitoba and its employees take no responsibility for the location of any underground pipes, conduits, or facilities, whether shown on or omitted from this plan. Facilities shown on this plan are for informational purposes only. Prior to any construction on lease or access road, TUNDRA ENERGY MARKETING LTD., MTS Communications Inc., Manitoba Hydro, and Manitoba Hydro-Gas Operations **MUST** be contacted for location of any underground facilities that may exist.

NO.	ISSUED	TH/DS/GA - AV - MB	Oct. 1, 2015
	REVISIONS	INITIALS	DATE

TUNDRA ENERGY MARKETING LTD.

CONSTRUCTION PLAN
 of
RIGHT-OF-WAY

Within
S. 1/2 & N.W. 1/4 Sec. 7
Twp. 12 - Rge. 26WPM
 &
N. 1/2 Sec. 12 &
S.W. 1/4 Sec. 13
Twp. 12 - Rge. 27WPM

Virden & North Hargrave Areas
Rural Municipality of Wallace-Woodworth
2015

Scale: 1 : 5000

FOR RIGHT OF WAY CONTINUATION
SEE PLAN 18895-C2

I certify that the survey represented by this plan is correct to the best of my knowledge.

OPERATOR: TUNDRA ENERGY MARKETING LTD.




K. TODD
 Manitoba Land Surveyor
 Witness

CROSSING TABLE

Drawing No.	Description	Status	Location
X1	Overhead Power Line - Operator: MB Hydro	Installed	Between NE 2 & SE 26-11-26WPM
X2	30.175 Government Road (Rural) Allowance - Medium Grade Gravel Road	Installed	Between NE 2 & SE 26-11-26WPM
X3	Buried Telecom Cable - Operator: MTS	Installed	Between NE 2 & SE 26-11-26WPM
X4	12 m MTS Canal No. 11587722 Buried Telecom Cable	Installed	SE 25-11-26WPM
X5	25 m RW - Operator: Tundra (Buried Pipe)	Installed	SE 25-11-26WPM
X6	Buried Pipe & Buried Power Cable - Operator: Tundra	Installed	NW 25-11-26WPM
X7	15 m Tundra Access Road - Trail	Installed	NW 25-11-26WPM
X8	Buried Power Cable - Operator: Tundra	Installed	NW 25-11-26WPM
X9	15 m RW - Operator: Tundra (Buried Pipes 2)	Installed	NW 24-11-26WPM
X10	15 m Tundra Access Road	Installed	NW 25-11-26WPM
X11	Buried Pipe - Operator: Tundra	Installed	NW 25-11-26WPM
X12	Buried Pipe (2) - Operator: Tundra	Installed	NW 25-11-26WPM
X13	Buried Power Cable (2) - Operator: Tundra	Installed	NW 25-11-26WPM
X14	15 m Eastment Plan 37168 SLO - Operator: T.E.M.L. (Buried Pipe)	Not To Be Installed	NW 25-11-26WPM
X15	Buried Power Cable - Operator: Tundra	Installed	NW 25-11-26WPM
X16	15 m RW - Operator: Tundra	Installed	NW 25-11-26WPM
X17	Buried Pipe - Operator: Tundra	Installed	NW 25-11-26WPM
X18	Buried Power Cable - Operator: Tundra	Installed	NW 25-11-26WPM
X19	15 m RW - Operator: Tundra (Buried Pipes)	Installed	NW 25-11-26WPM
X20	30.175 Government Road (Rural) Allowance - Medium Grade Gravel Road	Installed	Between NW 2 & SW 32-11-26WPM
X21	Scallop Creek (W)	Installed	SW 32-11-26WPM
X22	15 m Tundra Access Road - Trail	Installed	SW 32-11-26WPM
X23	Overhead Power Line - Operator: MB Hydro	Installed	Between NW 32-11-26WPM & SW 5-12-26WPM
X24	Buried Natural Gas Line - Operator: MB Hydro Gas Operations	Installed	Between NW 32-11-26WPM & SW 5-12-26WPM
X25	30.175 Government Road (Rural) Allowance - Medium Grade Gravel Road	Installed	Between NW 32-11-26WPM & SW 5-12-26WPM
X26	Buried Telecom Cable - Operator: MTS	Installed	Between NW 32-11-26WPM & SW 5-12-26WPM
X27	12 m MTS Canal No. 11587722 Buried Telecom Cable	Installed	SW 5-12-26WPM
X28	18.25 m MB Hydro Canal No. R626932 (Overhead Transmission Line)	Installed	SW 5-12-26WPM
X29	30.175 Government Road (Rural) Allowance - Medium Grade Gravel Road	Installed	Between SW 5 & SE 12-26WPM
X30	Buried Telecom Cable (2) - Operator: MTS	Installed	Between SW 5 & SE 12-26WPM
X31	Overhead Power Line - Operator: MB Hydro	Installed	Between SW 5 & SE 12-26WPM

* The revision stated in the Status column refers to the Construction Plan revision.

Total length of right-of-way along posted boundary: 5.71 km
 Crossings associated with this drawing: 31
 Crossing plans required: 30
 (Crossing plans issued for foreign crossings only)

LEGEND
 Placed Wooden Hub / Deflection Point shown thus: 
 Found Survey Monuments shown thus: 
 Right-of-Way boundary shown thus: 

NOTES
 All Marker Posts placed are 0.3 metres inside the GRA unless shown otherwise.
 Right-of-way to be 20.00 metres in perpendicular width throughout unless shown otherwise.
 - Asymtutes are grid and are referred to UTM projection, NAD 83 (Zone 14) datum and are derived by G.N.S.S.

DISCLAIMER:
 This plan represents the best information available at the time of survey. Atlas Geomatics Manitoba and its employees take no responsibility for the location of any underground pipes, conduits, or facilities, whether shown on or omitted from this plan. Facilities shown on this plan are for informational purposes only. Prior to any construction on lease or access roads, TUNDRA ENERGY MARKETING LTD., MTS Communications Inc., Manitoba Hydro, and Manitoba Hydro-Gas Operations MUST be contacted for location of any underground facilities that may exist.


NO.	ISSUED	THDS/GA - AVMT - MB	SEPT. 30, 2015
0	Issued	THDS/GA - AVMT - MB	SEPT. 30, 2015

TUNDRA ENERGY MARKETING LTD.

CONSTRUCTION PLAN
 of
RIGHT-OF-WAY
 Within
 S. 1/2 & N.W. 1/4 Sec. 29
 W. 1/2 Sec. 32
 Twp. 11 - Rge. 26WPM
 &
 S.W. 1/4 Sec. 5 &
 E. 1/2 Sec. 6
 Twp. 12 - Rge. 26WPM

Virden Area
 Rural Municipality of Wallace-Woodworth
 2015


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FOR RIGHT OF WAY CONTINUATION
 SEE PLAN 18895-C3

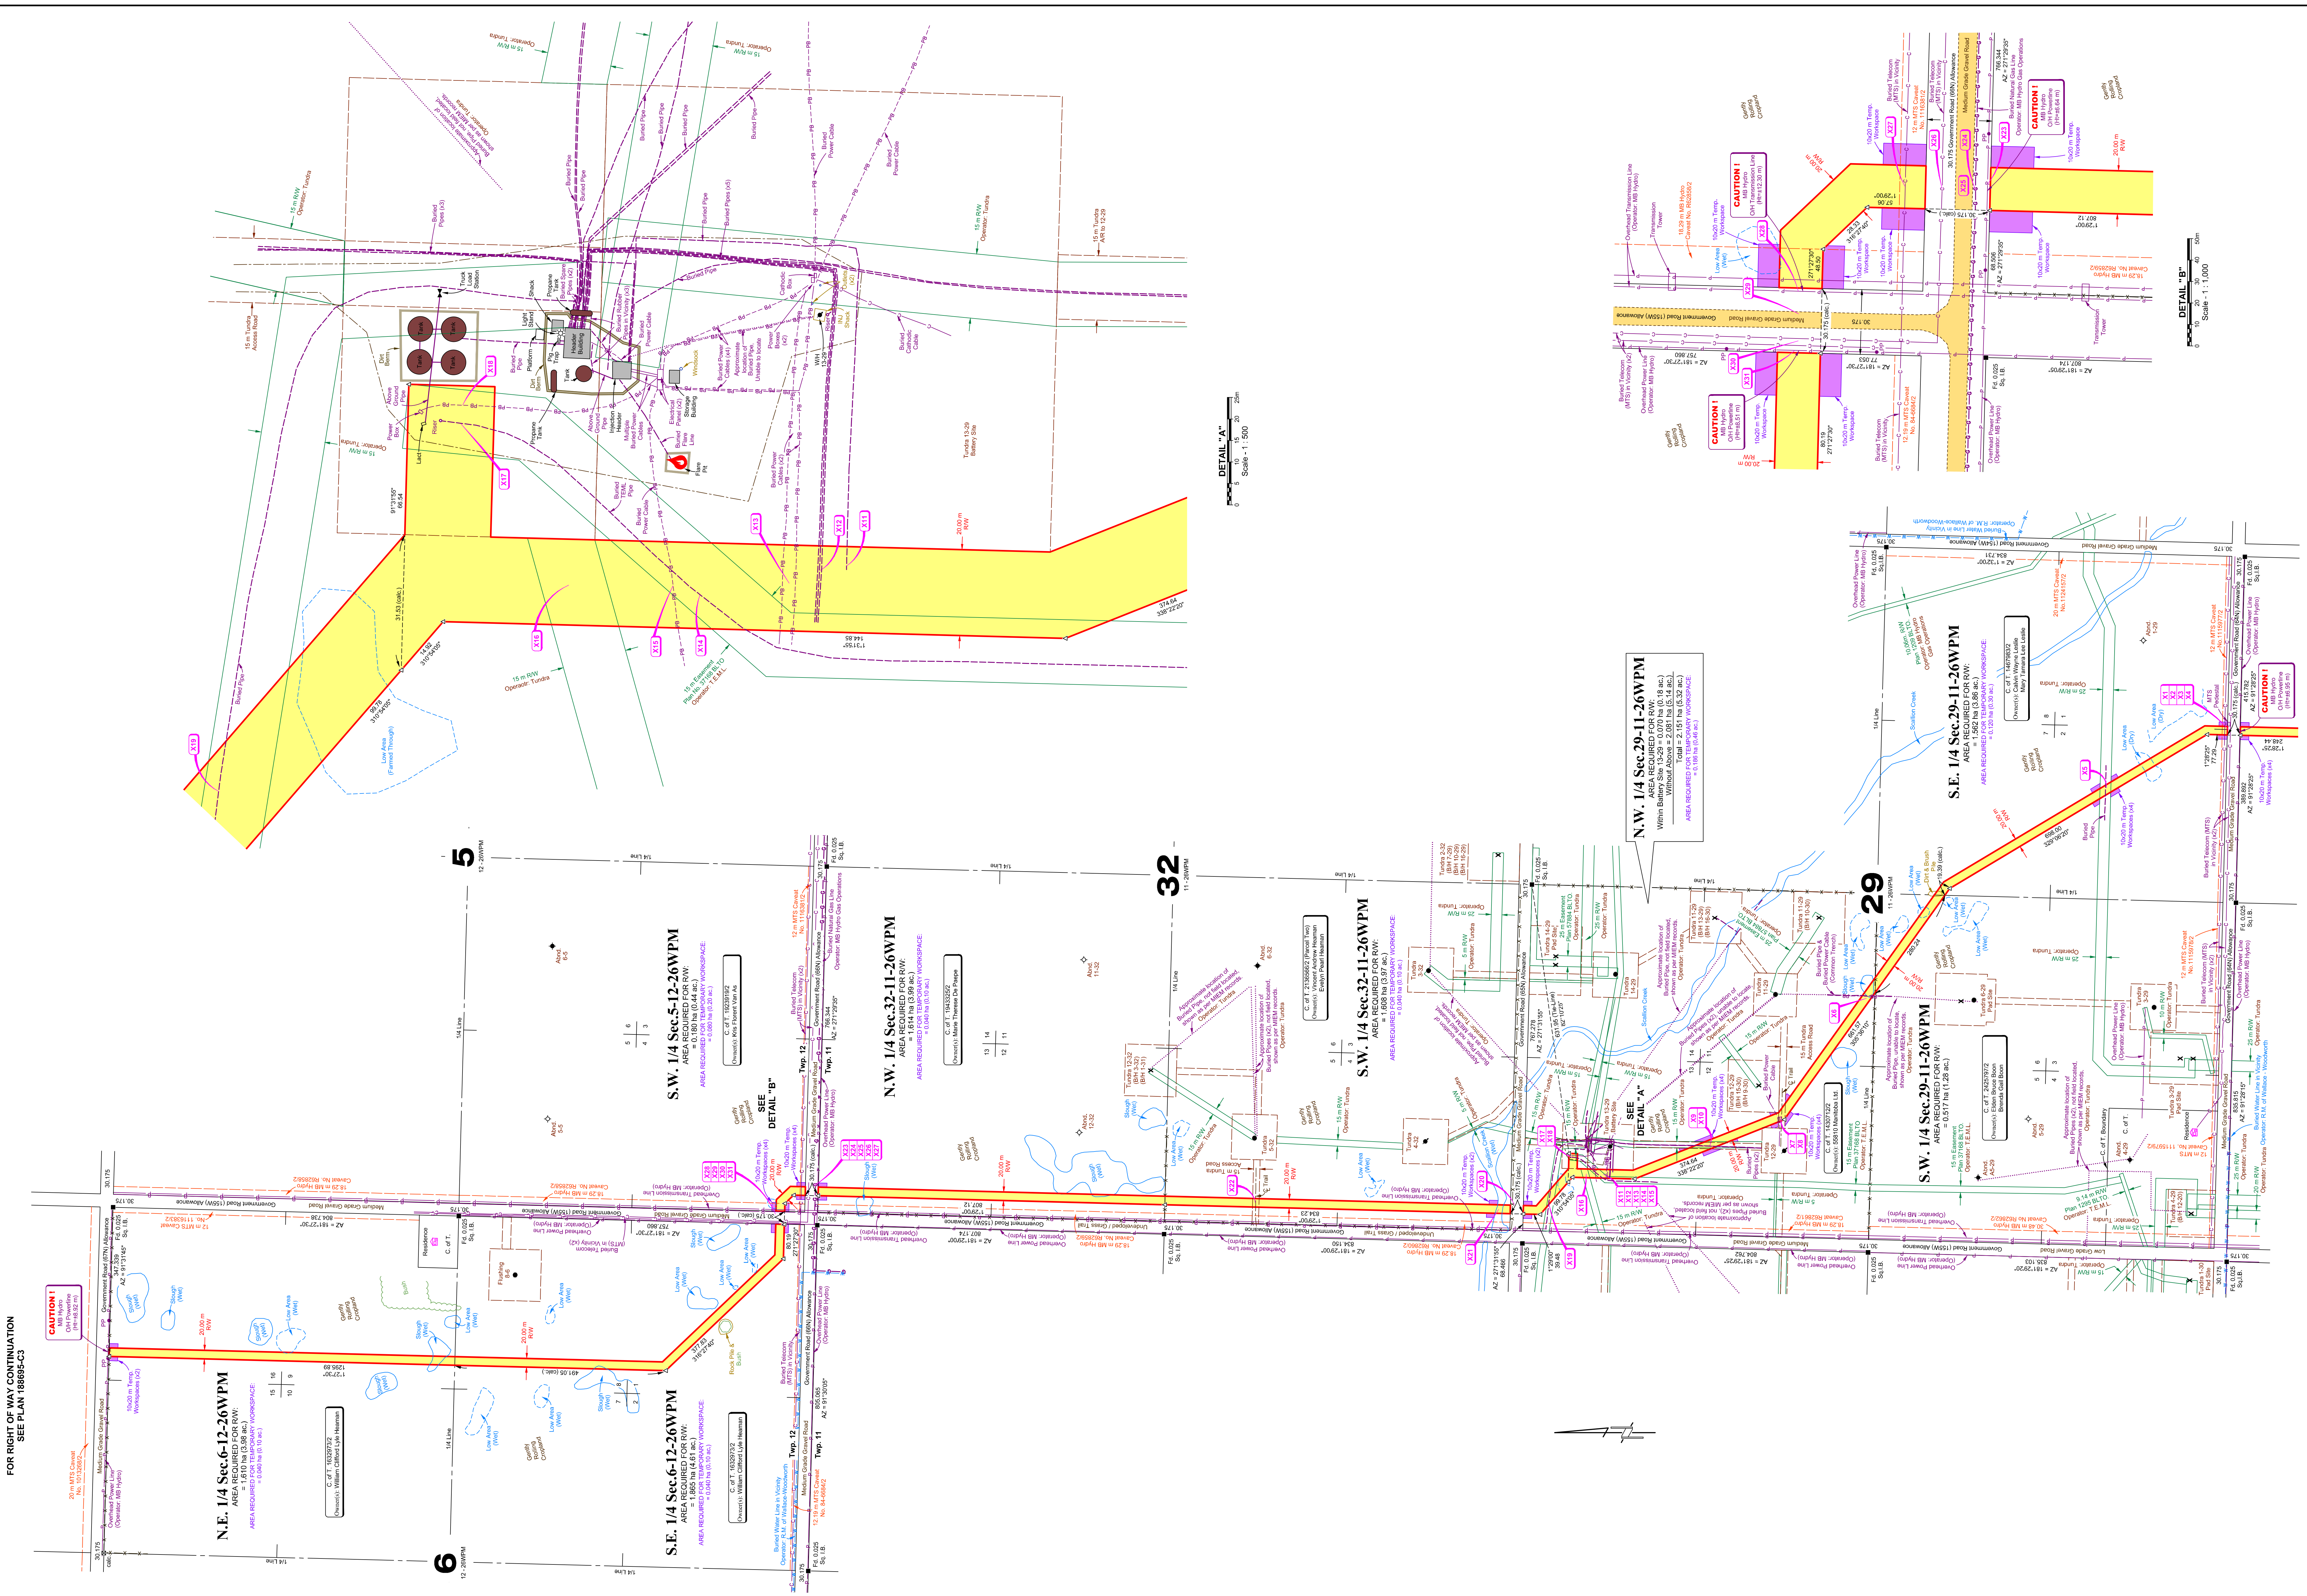
FOR RIGHT OF WAY CONTINUATION
 SEE PLAN 18895-C1

FOR RIGHT OF WAY CONTINUATION
SEE PLAN 188695-C2



20
11-26WPM

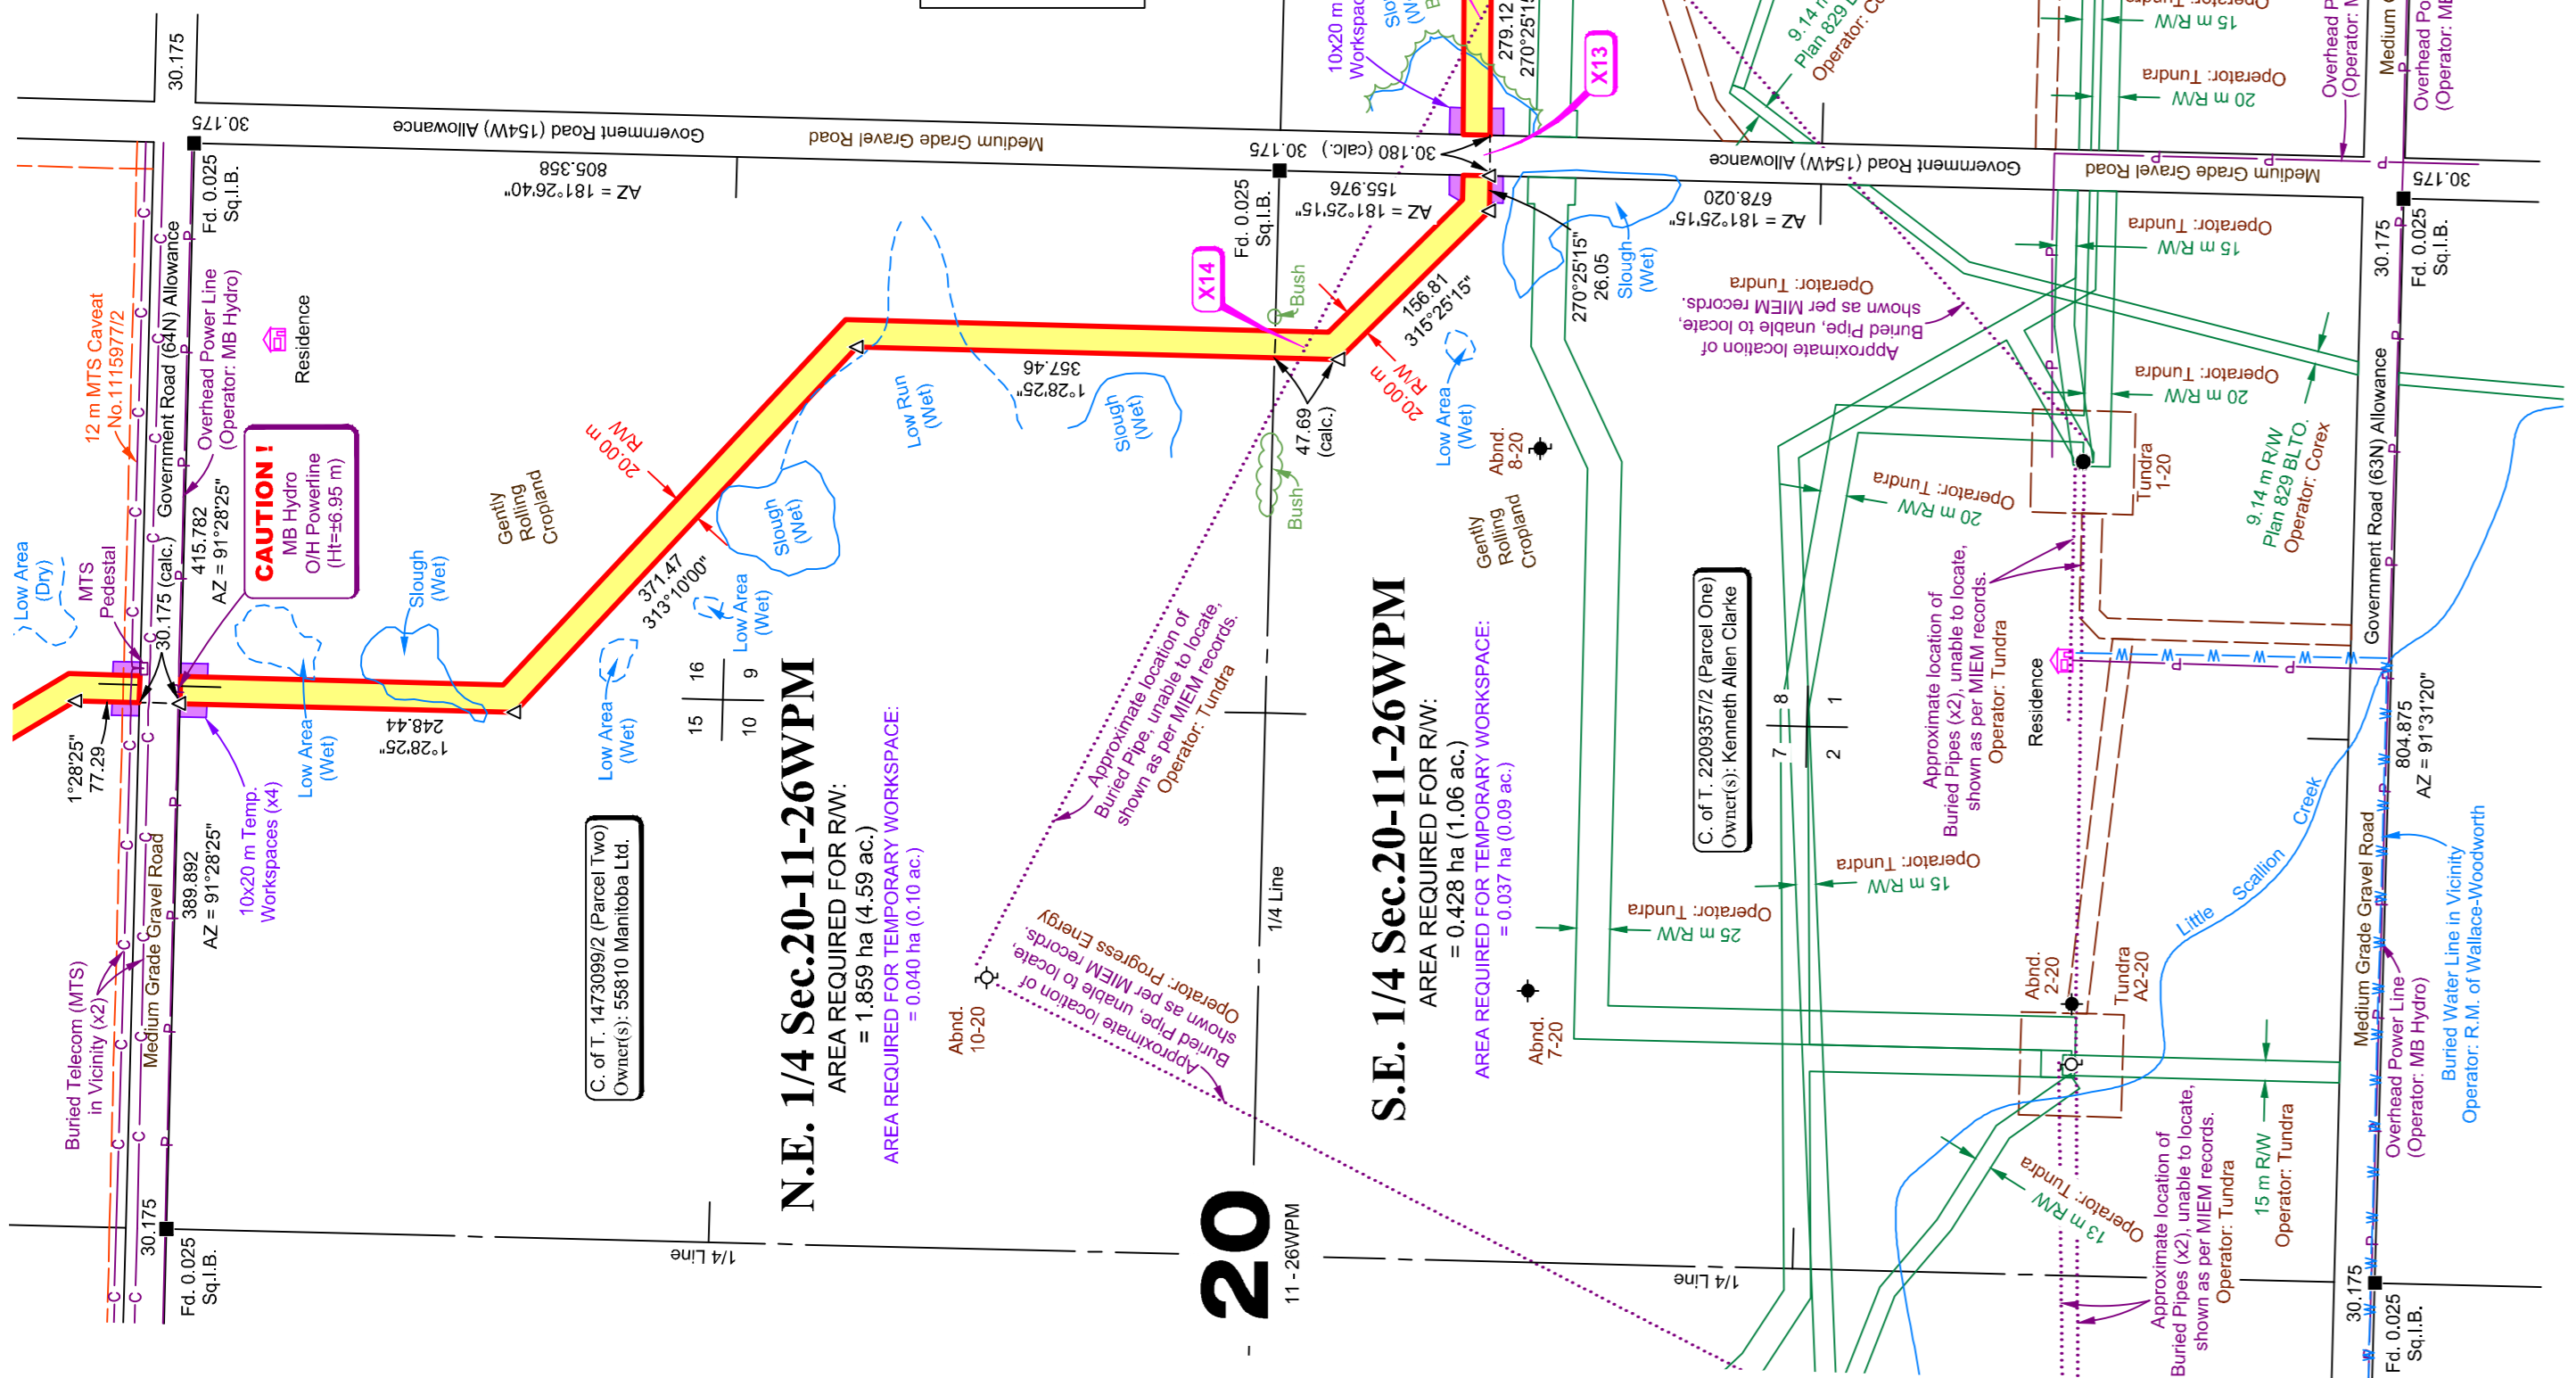21
11-26WPM

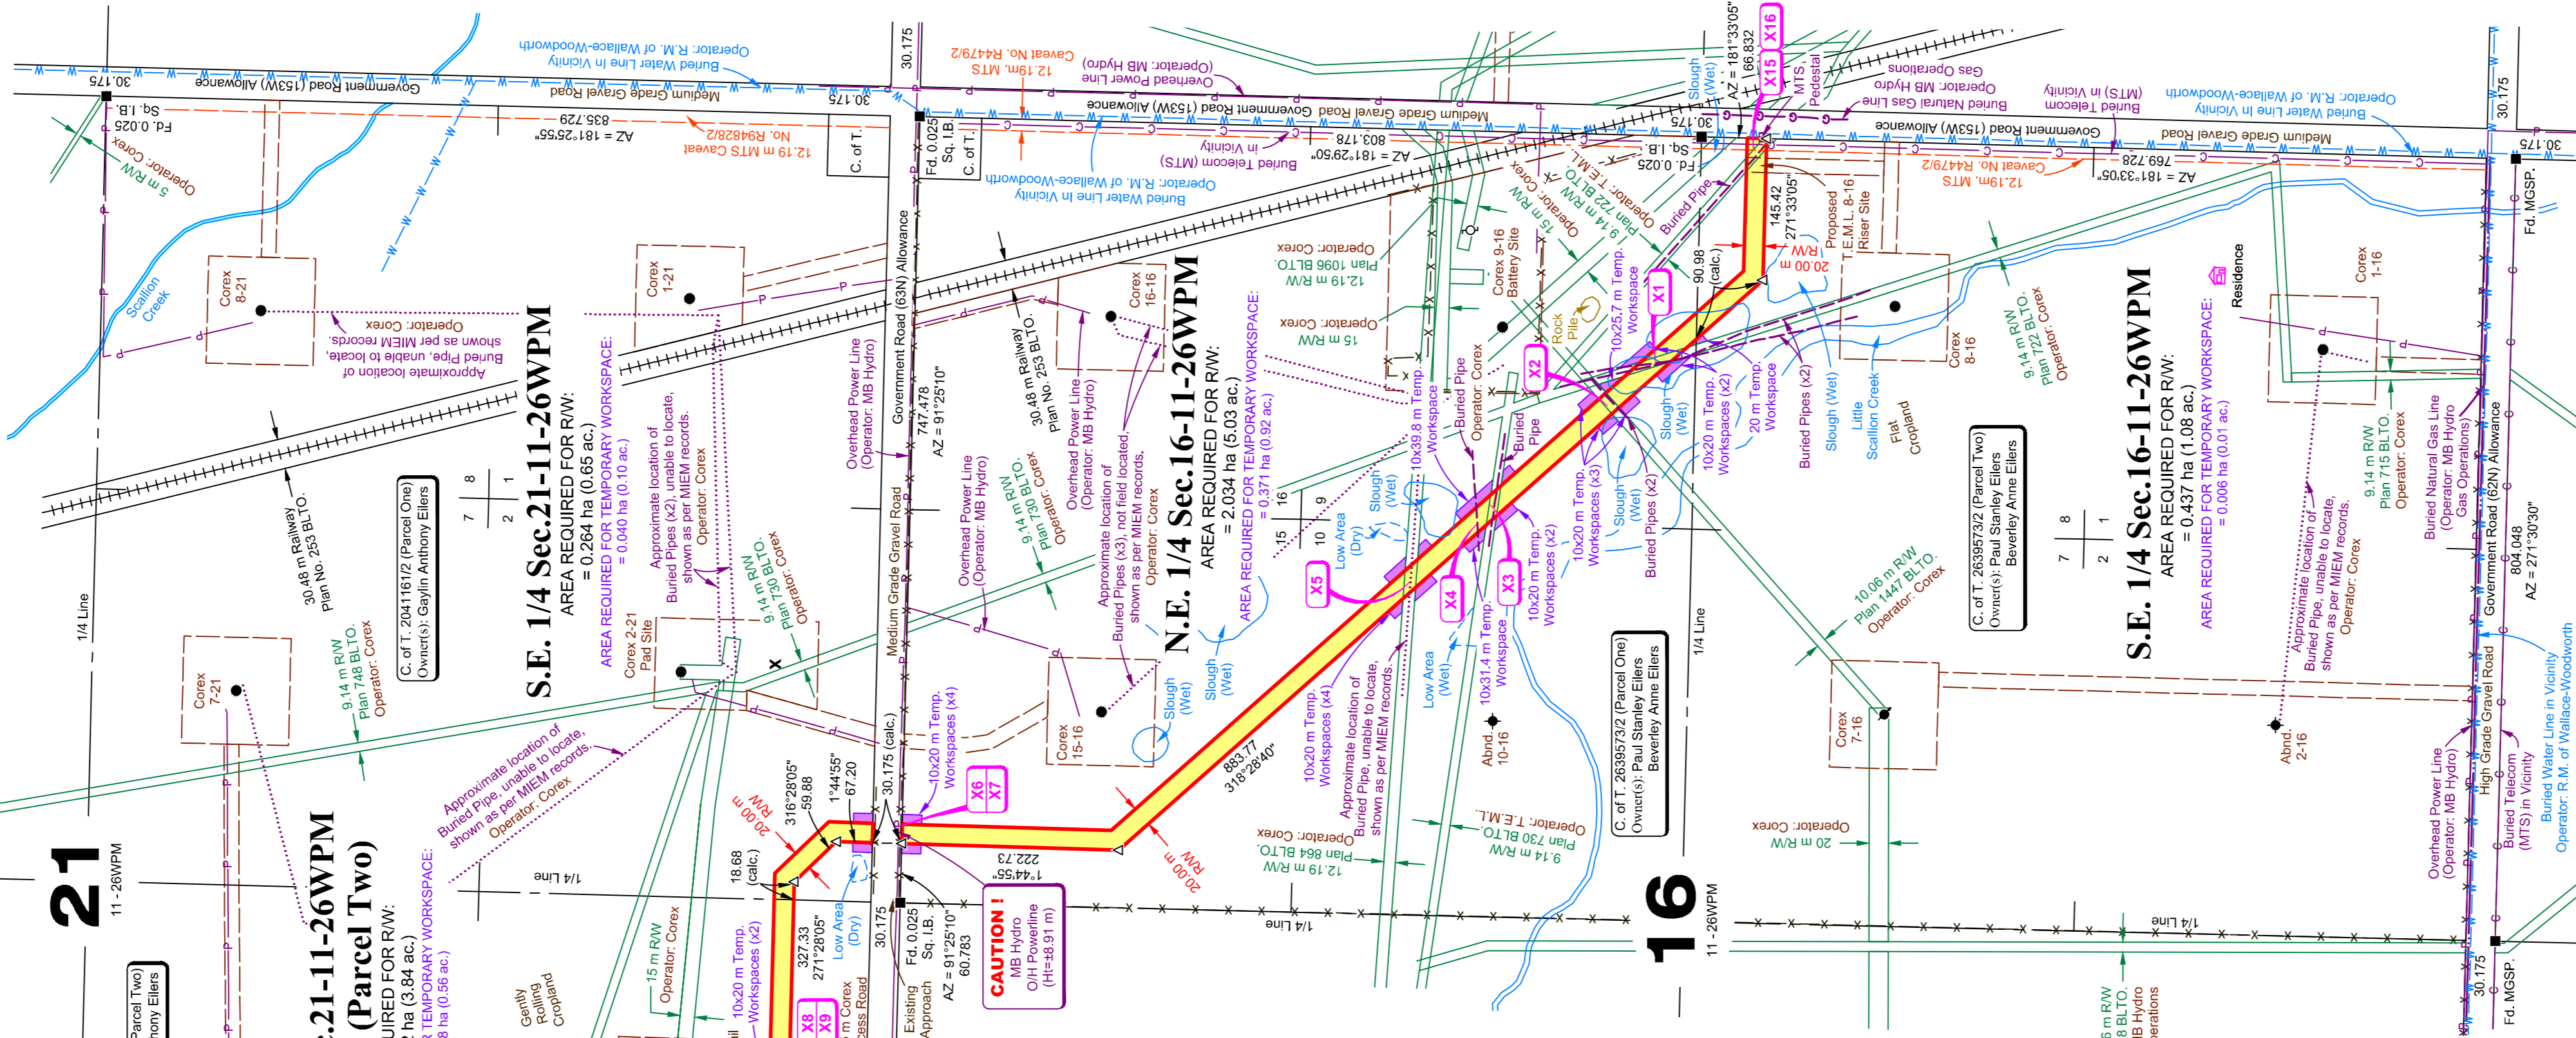

16
11-26WPM

17
11-26WPM

MLS AFFIDAVIT

I certify that the survey represented by this plan is correct to the best of my knowledge.

OPERATOR:
TUNDRA ENERGY MARKETING LTD.

K. Todd Kelly
Manitoba Land Surveyor

T. Kelly
Witness

CROSSING TABLE

Drawing No.	Description	Status	Location
X1	9.14 m RW Plan 722 B.L.T.O. - Operator: Corex (Buried Pipes x2)	Issued Rev.0	N.E. 16-11-26WPM
X2	10.08 m RW Plan 1447 B.L.T.O. - Operator: Corex (Buried Pipes x2)	Issued Rev.0	N.E. 16-11-26WPM
X3	9.14 m RW Plan 730 B.L.T.O. - Operator: T.E.M.L. (Buried Pipes)	Not To Be Issued	N.E. 16-11-26WPM
X4	Buried Pipe - Operator: Corex	Issued Rev.0	N.E. 16-11-26WPM
X5	12.19 m RW Plan 864 B.L.T.O. - Operator: Corex (Approximate Buried Pipe, Unable To Locate)	Issued Rev.0	N.E. 16-11-26WPM
X6	Overhead Power Line - Operator: MB Hydro	Issued Rev.0	Between N.E. 16 & S.E. 21-11-26WPM
X7	30.175 Government Road (63M) Allowance - Medium Grade Gravel Road	Issued Rev.0	Between N.E. 16 & S.E. 21-11-26WPM
X8	15 m Corex Access Road - Trail	Issued Rev.0	S.W. 21-11-26WPM
X9	Overhead Power Line - Operator: MB Hydro	Issued Rev.0	S.W. 21-11-26WPM
X10	10.08 m RW Plan 1185 B.L.T.O. - Operator: MB Hydro Gas Operations (Buried Gas Line)	Issued Rev.0	S.W. 21-11-26WPM
X11	9.14 m RW Plan 748 B.L.T.O. - Operator: Corex	Issued Rev.0	S.W. 21-11-26WPM
X12	Approximate Buried Pipe - Operator: Tundra	Issued Rev.0	S.W. 21-11-26WPM
X13	30.175 Government Road (154M) Allowance - Medium Grade Gravel Road	Issued Rev.0	Between S.E. 20 & S.W. 21-11-26WPM
X14	Approximate Buried Pipe - Operator: Tundra	Issued Rev.0	S.E. 20-11-26WPM
X15	12.19 m MTS Caveland No. R44792 (Buried Telecom Cable)	Issued Rev.0	S.E. 16-11-26WPM
X16	9.14 m RW Plan 722 B.L.T.O. - Operator: T.E.M.L. (Buried Pipes)	Not To Be Issued	S.E. 16-11-26WPM

* The revision stated in the Status column refers to the Construction Plan revision.

Total length of right-of-way along posted boundary : 3.83 km
Crossings associated with this drawing: 16
Crossing plans required : 14
(Crossing plans issued for foreign crossings only)

LEGEND

Placed Boundary Hub / Deflection Point shown thus: ———— Δ

Found Survey Monuments shown thus: ———— ■

Right - of - Way boundary shown thus: ————

NOTES

- All Marker Posts placed are 0.3 metres inside the GRA unless shown otherwise
- Right-of-way to be filed is 20.00 metres in perpendicular width throughout unless shown otherwise.
- Azimuths are grid and are referred to UTM projection, NAD 83 (Zone 14) datum and are derived by G.N.S.S.

DISCLAIMER:

This plan represents the best information available at the time of survey. Altus Geomatics Manitoba and its employees take no responsibility for the location of any underground pipes, conduits, or facilities, whether shown on or omitted from this plan. Facilities shown on this plan are for informational purposes only. Prior to any construction on lease or access road, TUNDRA ENERGY MARKETING LTD., MTS Communications Inc., Manitoba Hydro, and Manitoba Hydro-Gas Operations **MUST** be contacted for location of any underground facilities that may exist.


NO.	ISSUED	INITIALS	DATE
0	Issued	TH/D/S/GA - AV - MB	Oct. 2, 2015

TUNDRA ENERGY MARKETING LTD.

CONSTRUCTION PLAN
of
RIGHT-OF-WAY

Within
E. 1/2 Sec. 16
E. 1/2 Sec. 20
&
S. 1/2 Sec. 21
Twp. 11 - Rge. 26WPM

Viriden Area
Rural Municipality of Wallace-Woodworth
2015

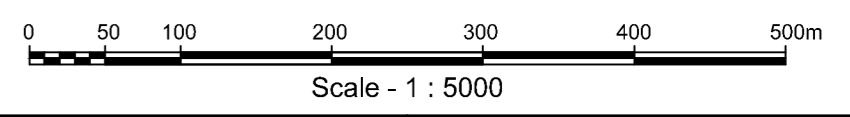

Appendix C

Plot Plan


To be provided subsequent to original submission

Appendix D

Crossing Typical

1 2 3 4 5 6 7 8

SCHEDULE									
CROSSING NUMBER	LOCATION	TYPE OF CROSSING	CARRIER PIPE			CARRIER PIPE UNDER CREEK			MEDIUM CARRIED
			O.D.	W.T.	SPECIFICATION	O.D.	W.T.	SPECIFICATION	
-	-	-	-	-	-	-	-	-	-
-	-	-	-	-	-	-	-	-	-
-	-	-	-	-	-	-	-	-	-
-	-	-	-	-	-	-	-	-	-
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-	-	-	-	-	-	-	-	-	-
-	-	-	-	-	-	-	-	-	-
-	-	-	-	-	-	-	-	-	-

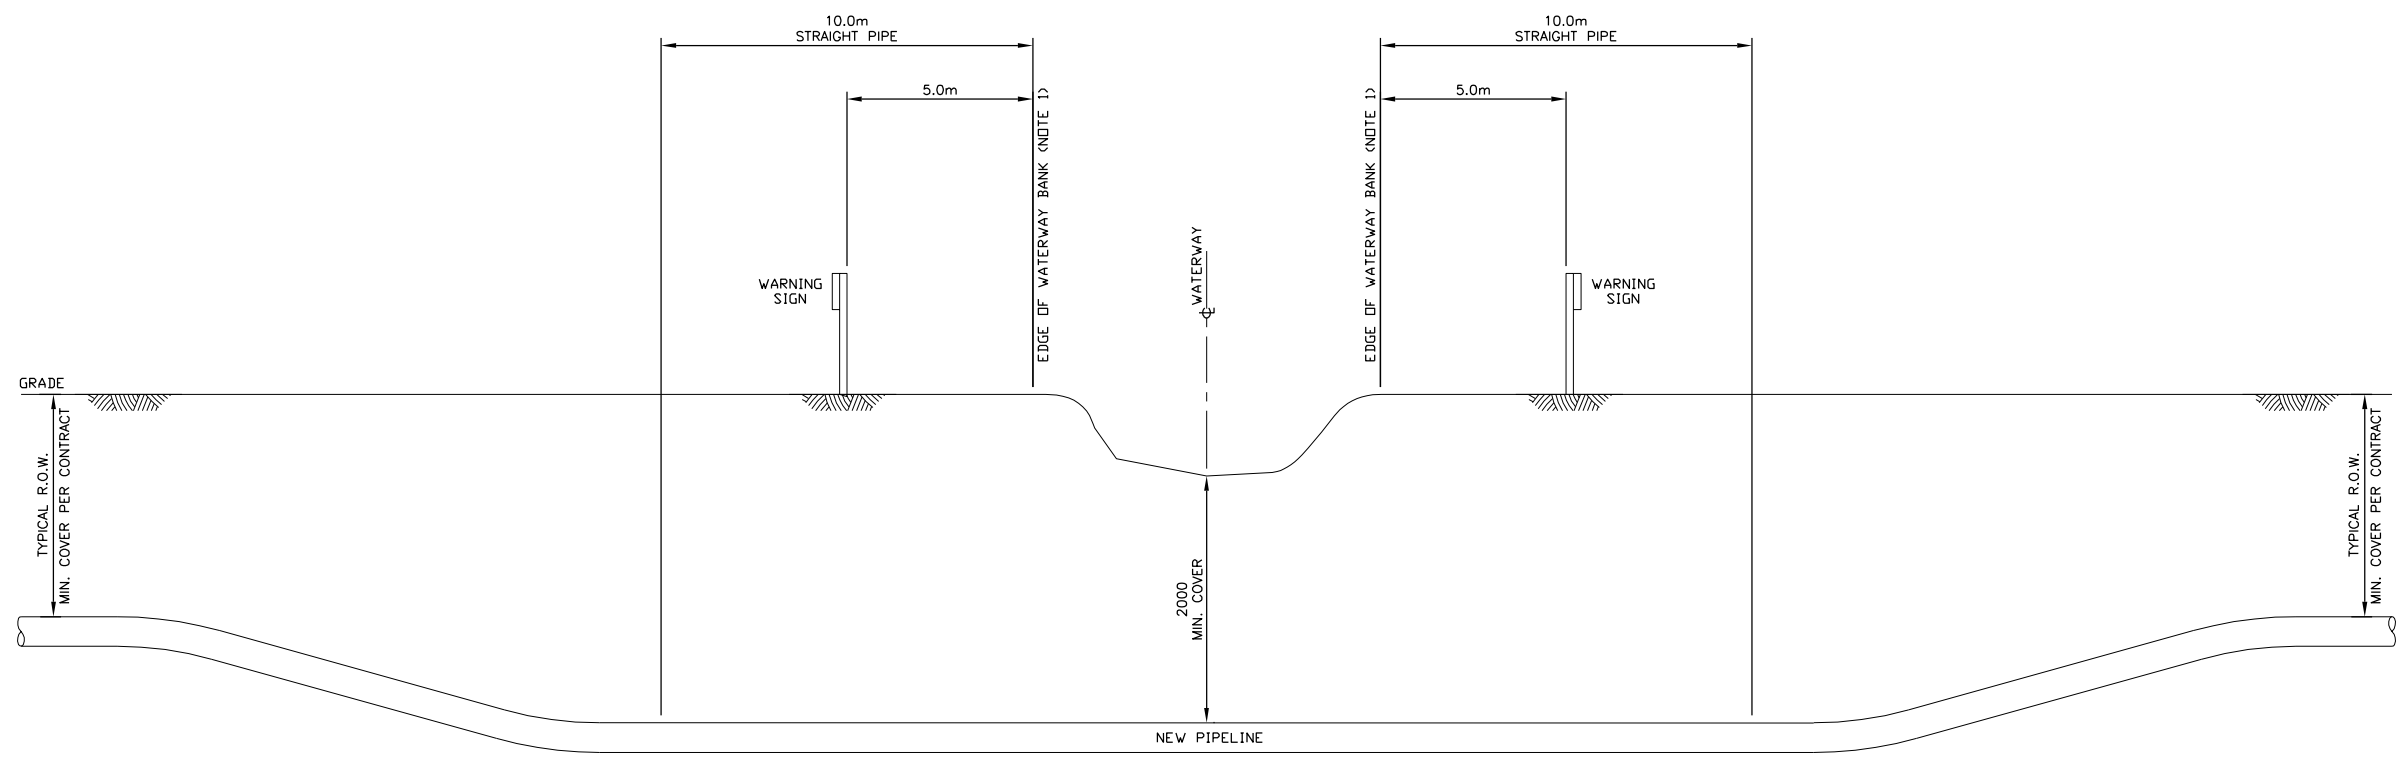

S:\LOCATIONS\PIPELINES\MB3-34-12-27 TO 5-15-11-26 W1M TWO CREEKS\DRAWINGS\03-34-012-27W1M_T-9321.DWG, Monday, 2015-Oct-05, 2:49 PM
 LAST SAVED: Monday, 2015-Oct-05, 11:02 AM BY: S.GUO

NOTES	
1. EDGE IS DETERMINED BY ENVIRONMENTAL MONITOR, OR COMPANY REPRESENTATIVE.	

REFERENCE DRAWINGS			
NUMBER	TITLE	NO.	ISSUE

REVISIONS									
NO.	ISSUE	DATE	BY	CHK'D	ENG	APP'D			


PERMIT AND ENGINEER STAMP			
CHECKED	DATE	APPROVED	DATE
-	YYY.MMM.DD	-	YYY.MMM.DD

ASHER ENGINEERING

TUNDRA ENERGY MARKETING LIMITED
 LSD: 03-34-012-27 W1M
 TWO CREEKS PIPELINE
 TYPICAL WATERWAY CROSSING DETAIL - TRENCHLESS
 CADFILE 03-34-012-27W1M_T-9321
 DRAWING NO. 03-34-012-27W1M_T-9321
 REV.

PROJ. NO.	2010	DRAWING NO.	03-34-012-27W1M_T-9321	REV.
SCALE	NTS			

S:\LOCATIONS\PIPELINES\MB\3-34-12-27 TO 5-15-11-26 W1M TWO CREEKS\DRAWINGS\03-34-012-27W1M_T-9341.DWG, Thursday, 2015-10-01, 3:33 PM
 LAST SAVED: Thursday, 2015-10-01, 2:00 PM BY: S.GUO

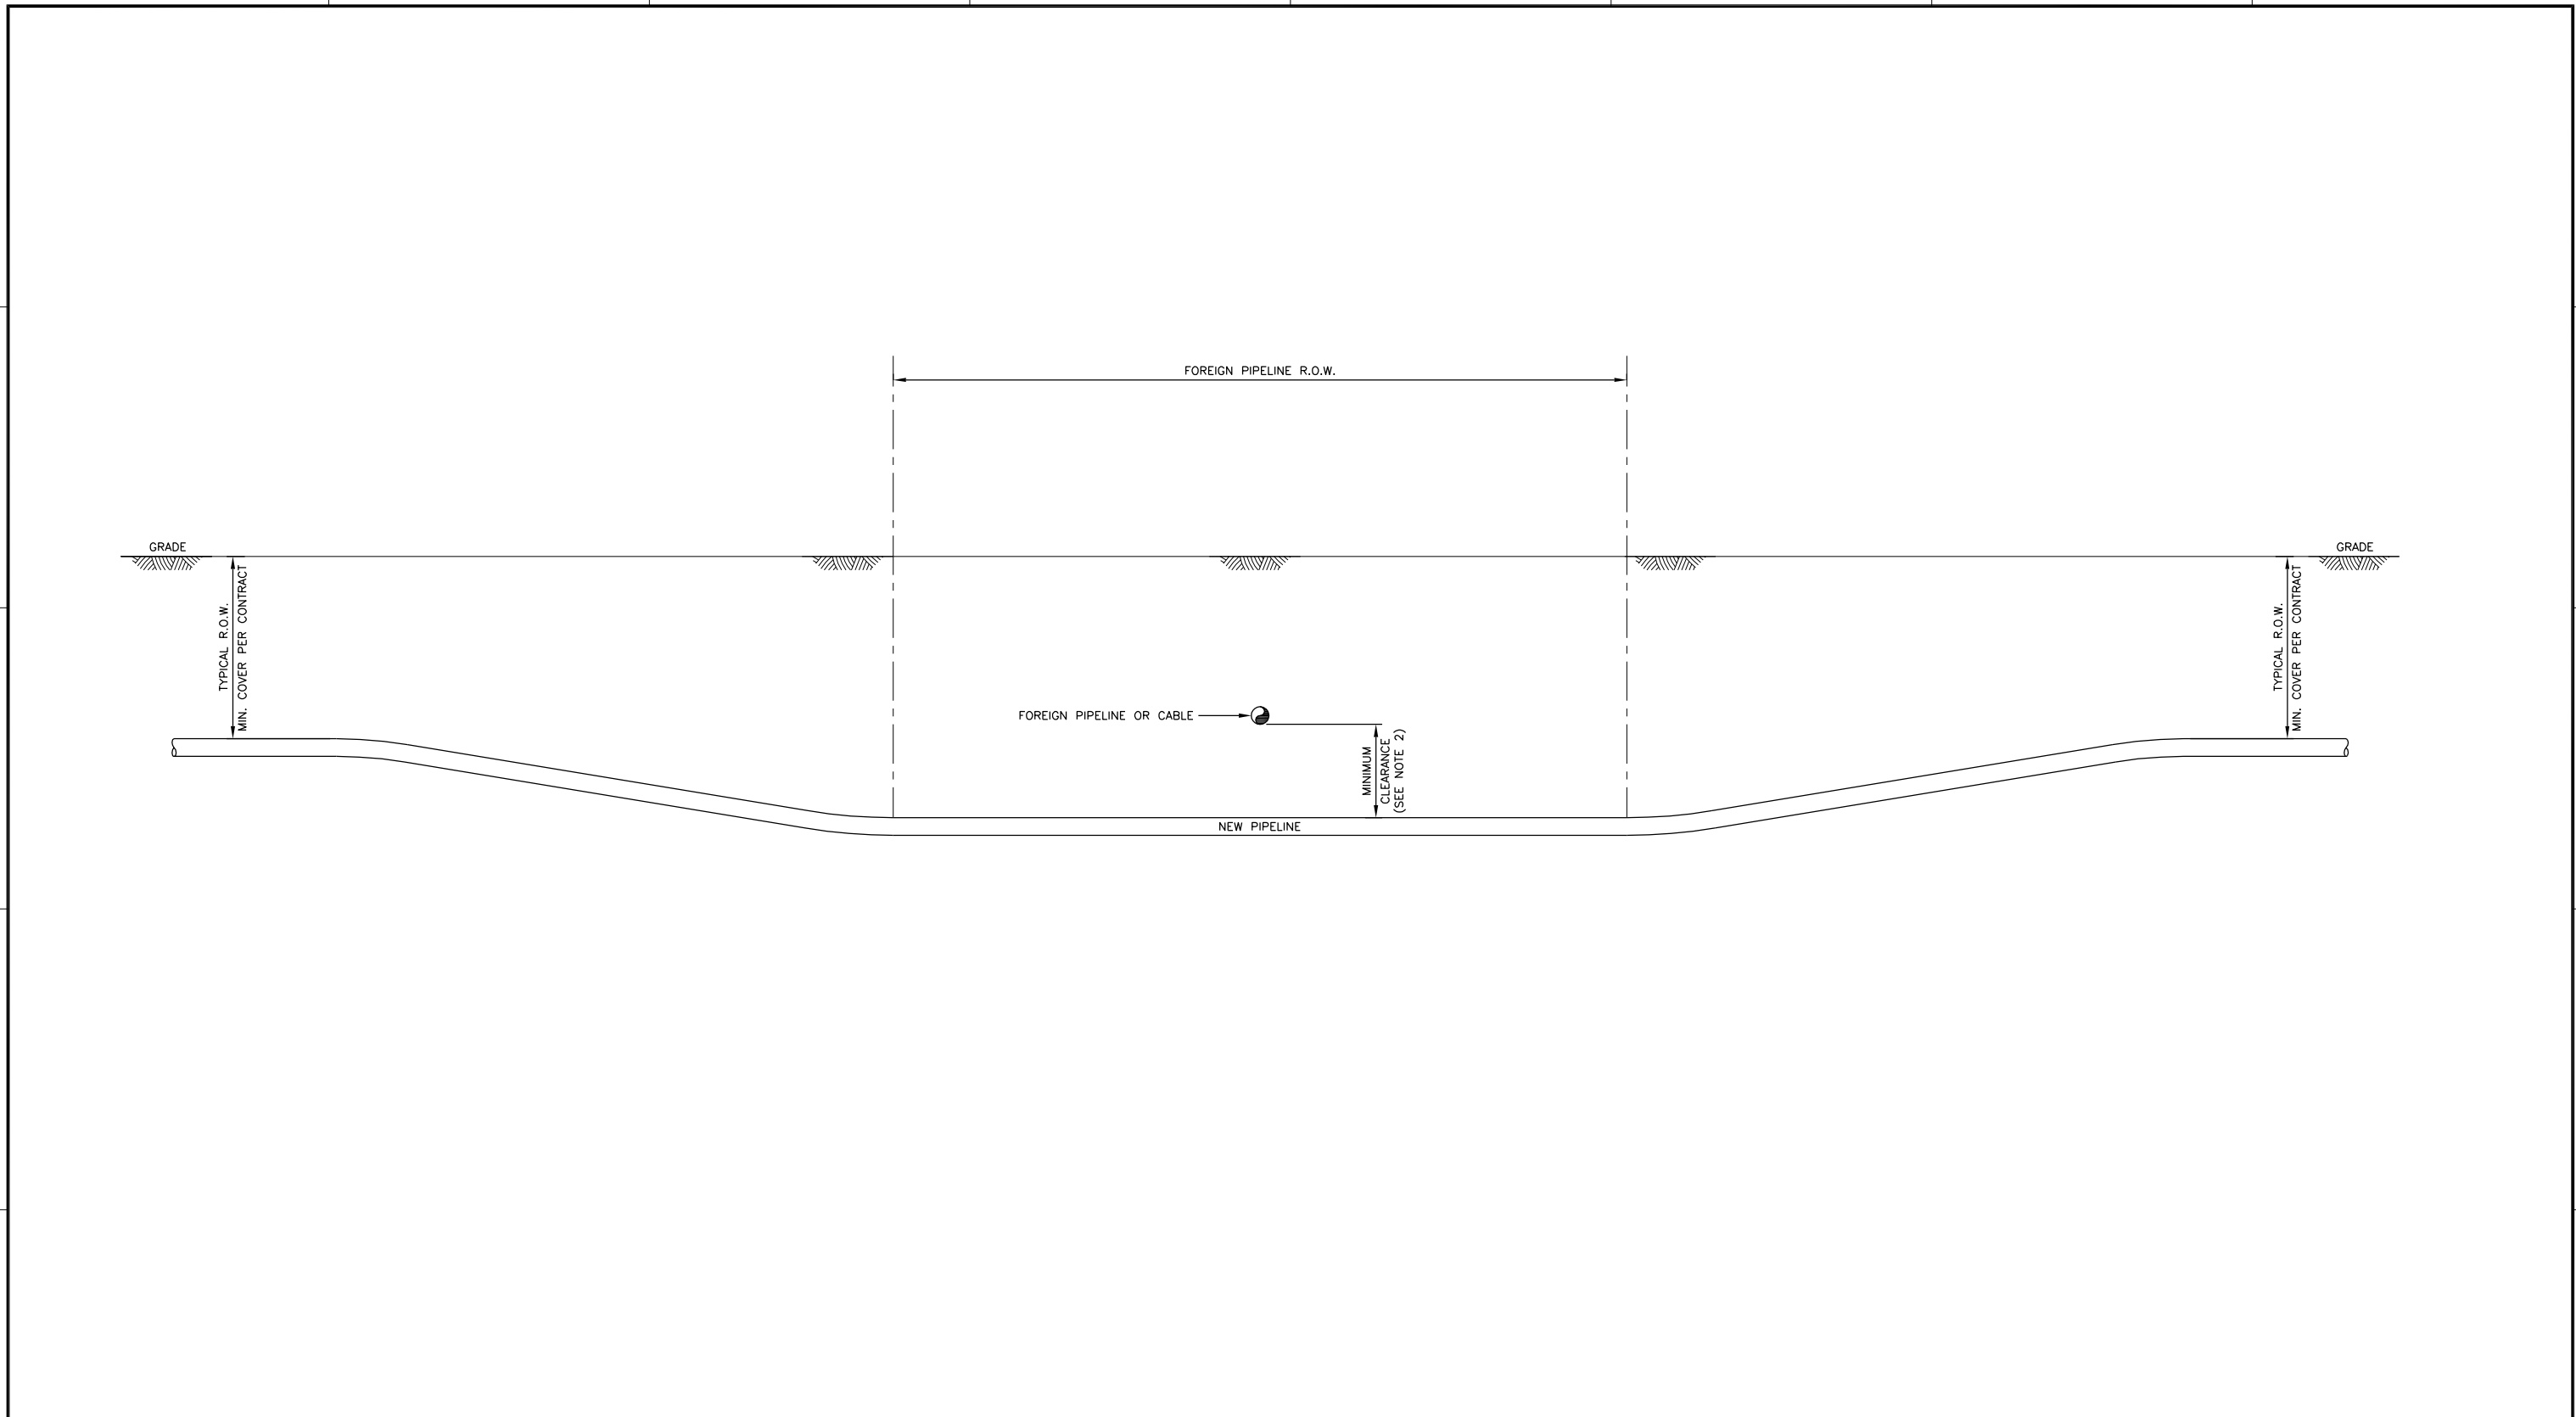

NOTES: (CONT'D)
 7. FOREIGN PIPELINE, CABLE, UTILITY SHALL BE SUPPORTED AT CROSSING LOCATION, IF REQUIRED.


NOTES		REFERENCE DRAWINGS		REVISIONS							PERMIT AND ENGINEER STAMP			
NO.	DESCRIPTION	NUMBER	TITLE	NO.	ISSUE	DATE	BY	CHK'D	ENG	APP'D	SIGNATURE		DATE	SCALE
1.	INSTALLATION SHALL MEET REQUIREMENTS OF CSA Z662, LATEST EDITION.													
2.	MINIMUM CLEARANCE SHALL BE 300mm OR AS SPECIFIED IN THE CROSSING AGREEMENT, WHICHEVER IS GREATER.													
3.	IF THE FOREIGN PIPELINE CONTAINS SOUR GAS, APPROPRIATE SAFETY EQUIPMENT SHALL BE AVAILABLE AT THE WORKSITE.													
4.	ALL THE TERMS AND CONDITIONS OF THE CROSSING AGREEMENT SHALL BE STRICTLY ADHERED TO.													
5.	FOREIGN PIPELINE, CABLE, UTILITY SHALL BE HAND OR HYDROVAC DAYLIGHTED PRIOR TO EXCAVATION.													
6.	NO MACHINE EXCAVATION SHALL TAKE PLACE WITHIN 2000mm OF A FOREIGN PIPELINE, CABLE, UTILITY, CROSSING, OR WITHIN SUCH DISTANCE AS IS SPECIFIED IN THE CROSSING AGREEMENT.													

TUNDRA ENERGY MARKETING LIMITED
 LSD: 03-34-012-27 W1M
 TWO CREEKS PIPELINE
 FOREIGN CROSSING DETAIL
 CADFILE: 03-34-012-27W1M_T-9341
 DRAWING NO. 03-34-012-27W1M_T-9341
 REV.

Appendix E

Process Flow Diagram

S:\LOCATIONS\PIPELINES\MB\3-34-12-27 TO 5-15-11-26 W1M TWO CREEKS\DRAWINGS\03-34-012-27W1M_F-2011_REVA.DWG, Wednesday, 2015-Sep-30, 9:50 AM
 LAST SAVED: Wednesday, 2015-Sep-30, 9:40 AM BY: S.GUO

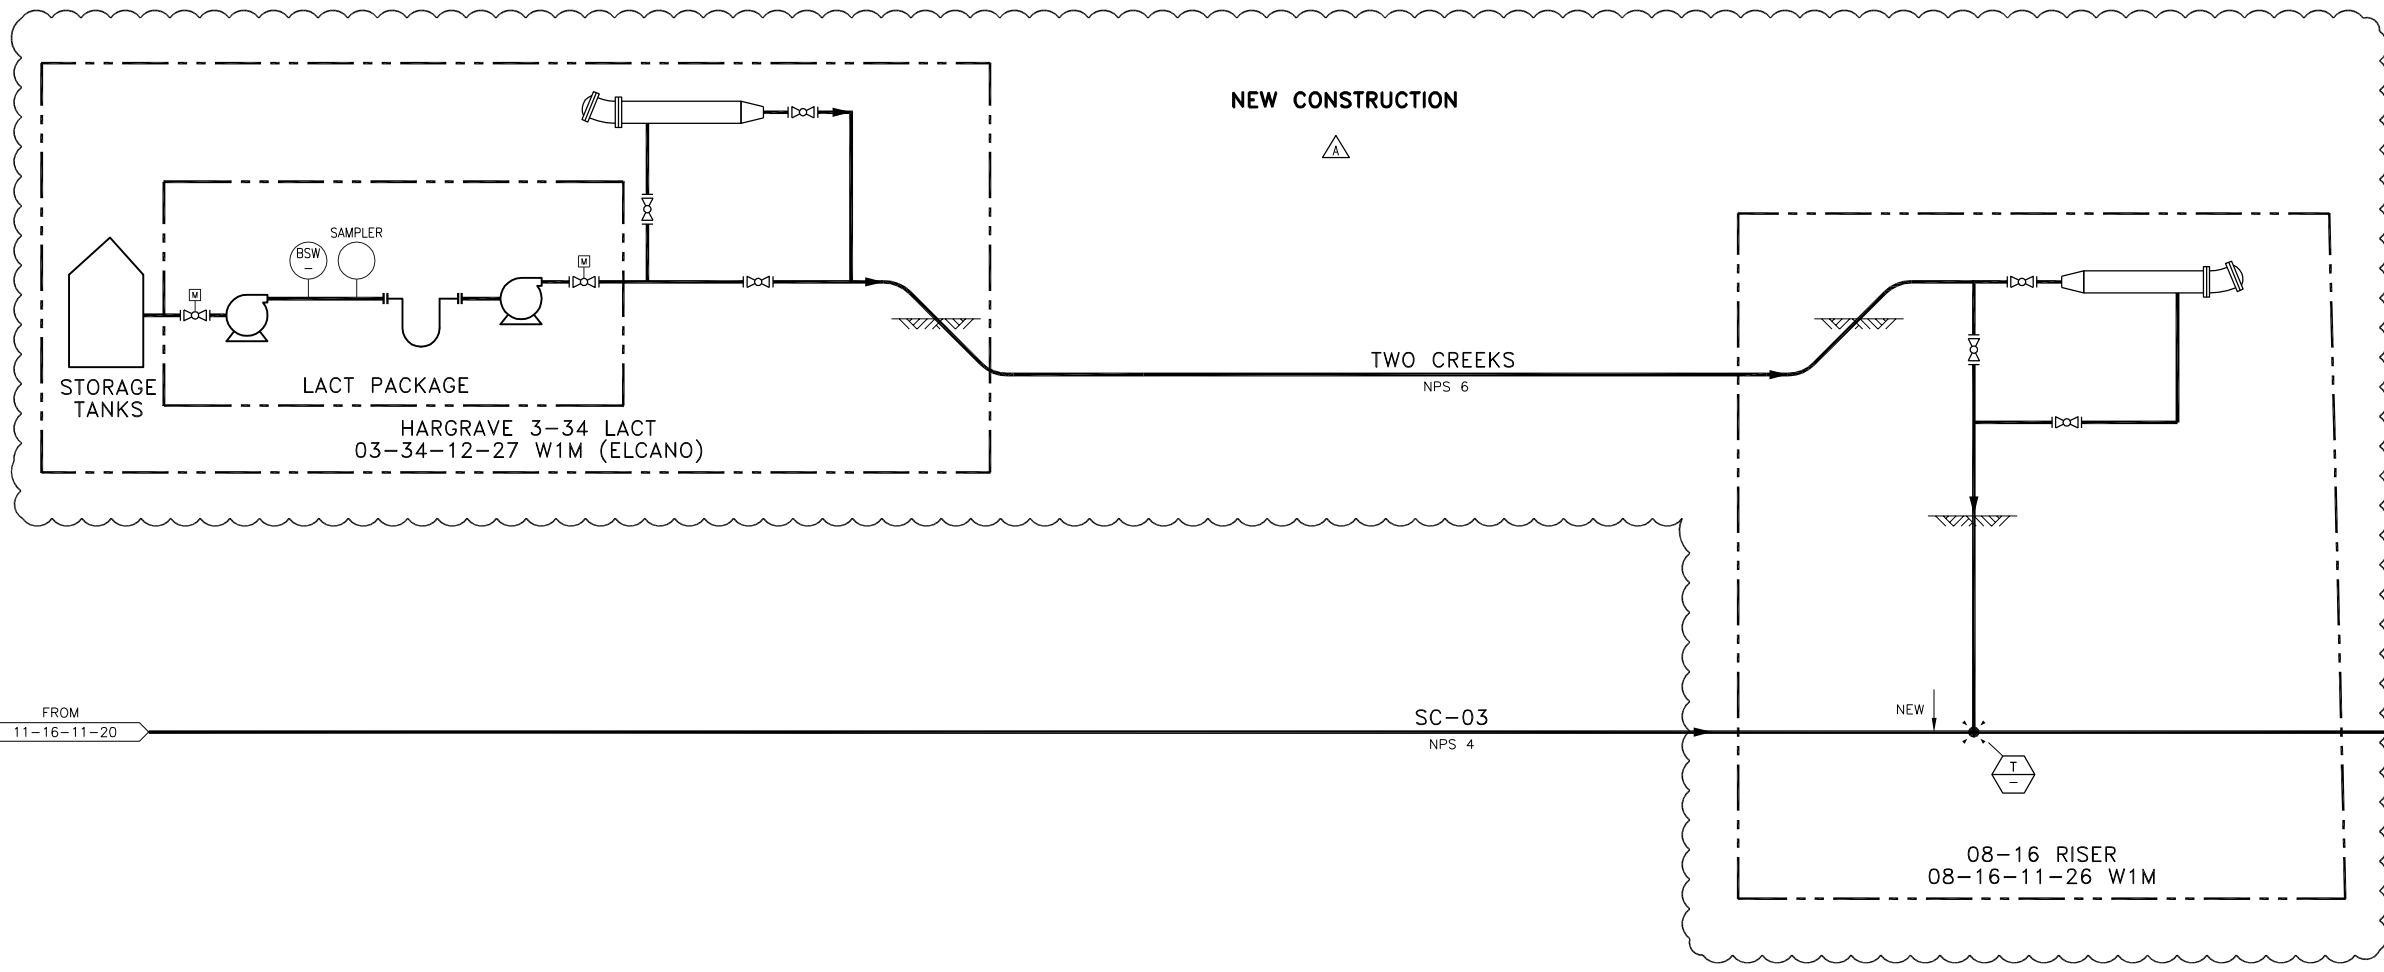

SOUR SERVICE

NOTES		REFERENCE DRAWINGS		REVISIONS							PERMIT AND ENGINEER STAMP				PROJECT INFORMATION		DRAWING INFORMATION	
NUMBER	TITLE	NO.	ISSUE	DATE	BY	CHK'D	ENG	APP'D	CHECKED	DATE	APPROVED	DATE	PROJ. NO.	SCALE	DRAWING NO.	REV.		
		A	ISSUED FOR APPROVAL	2015.SEPT.11	BK								2010	NTS	03-34-012-27W1M F-2013 RevA	A		

PRELIMINARY

ASHER ENGINEERING

TUNDRA ENERGY MARKETING LIMITED

03-34-012-27 TO 08-16-11-26 W1M
 TWO CREEKS NPS 6 PIPELINE SYSTEM
 PROCESS FLOW DIAGRAM
 SOUR OIL SALES PIPELINE

CADFILE: 03-34-012-27W1M_f-2013_revA
 PROJ. NO.: 2010
 SCALE: NTS
 DRAWING NO.: 03-34-012-27W1M F-2013 RevA
 REV.: A

Appendix F

Pipeline Technical Data

**Tundra Energy Marketing Limited
Proposed Pipeline Details**

		NPS 6
Starting LSD & Facility		03-34-12-27 WPM Elcano Battery 03-34
Ending LSD & Facility		08-16-11-26 WPM Riser Site
Fluid being transported		crude oil & LVP products
Length (Apprx.)	m	20,000
Outside Diameter	mm	168.3
Wall Thickness	mm	4.8
Grade		Grade 359 Cat II Sour
External Coating		YJ or YJ2K as required
Expected (Max) Flow Rate	m³/day	2000
Design Pressure	kPag	9930
Maximum Operating Pressure	kPag	9930
Line Pipe Standard		CSA Z245.1-14
Valves Standard		CSA Z245.15-13 or Note below
Flanges Standard		CSA Z245.12-13 or Note below
Fittings Standard		CSA Z245.11-13 or Note below

Notes:

1. Pipe, valves, and fittings that will be used are in accordance with the requirements of CSA Z662-15.
2. The CSA Z662 requirements include the above listed CSA Z245.XX-YY standards as well as others.

Appendix G

Line List

SENT BY SEPARATE SUBMISSION

Appendix H

Environmental Protection Plan

SENT BY SEPARATE SUBMISSION

Appendix I

Environmental Pre-Development Assessment

SENT BY SEPARATE SUBMISSION