

vironmental Centre es of Development Regulation:					
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a Avenue Province: MB Postal Code: R3N0T1 Email: daveh@millerenvironmental.mb.ca					
ses of the environmental assessment (e.g. consultant):					
Mailing address: 1803 Hekla Avenue, Winnipeg, MB R3N 0T1 I.mb.ca					
ecters):					
re: name: Dave Howes					
A complete Notice of Alteration (NoA) Submit the complete NoA to:   consists of the following components: Director   ✓ Cover letter Environmental Approvals Branch   ✓ Notice of Alteration Form 1007 Century Street   ✓ the NoA detailed report (see "Information 1007 Century Street   Bulletin - Alteration to Developments With Environment Act Licences")   ↓ \$500 Application fee, if applicable (Cheque, payable to the Minister of Finance) Phone: (204) 945-8321   Note: Per Section 14(3) of the Environment Act Proposal Form (see "Information Bulletin – Environment Act Major Notices of Alteration must be filed thro					



#### Miller Environmental Corporation

1803 Hekla Avenue Winnipeg, Manitoba R2R 0K3 Tel. (204) 925-9600 Fax (204) 925-9601

Committed to Leadership in Our Industry

June 15, 2021

Manitoba Conservation and Climate Environmental Approvals Branch 1007 Century Street Winnipeg, MB R3H 0W4

Attention: Laura Pyles, Director (Acting), Environmental Approvals Branch

Dear Ms. Pyles:

RE: Dangerous Goods Handling and Transportation Act Licence 58 HW S2 RRRR

Please accept this as Miller Environmental Corporation's (Miller) notification for the installation of a new leachate pond as regulated under the issued Dangerous Goods Handling & Transportation Act License No. 58 HW S2 RRRR.

Miller has been working with Crocus Environmental Inc. to provide the engineered drawings and construction details to support the leachate pond installation. For leachate pond details, please refer to Appendix A – Leachate Pond Stamped Construction Drawings. The new leachate pond will be located on the east side of repository cell 3 (RC3). The 60 m x 58 m bermed pond will be lined with a 60 mil HDPE liner with a 2 m below grade depth. Leachate discharge lines will run from existing berm separated leachate containment area within the repository cells (RC1, RC2, and RC3) to the leachate pond. Discharge lines will allow for circulation and evaporation of leachate by controlled distribution onto the segregated black 60 mil HDPE liner. This will allow for maximum evaporation as well as reduce the accumulation of precipitation with leachate, thereby reducing overall leachate volumes. This is intended as an enhancement and addition to the current leachate management plan allowing for application of leachate to the operating areas of the repository for dust control.

For details of the location of the leachate pond, refer to Appendix B – Leachate Pond Location Details.

The leachate pond will be covered with a LLDPE liner (details as per engineered drawings). A negative air pressure system will be installed to secure the cover, prevent odour release and separate precipitation from leachate.


If you have any questions, please feel free to contact me at 204-925-9604 or by email at daveh@millerenvironmental.mb.ca


Sincerely yours, Miller Environmental Corporation




Dave Howes Director of Regulatory Affairs CC: Tyler Kneeshaw – Regional Supervisor, Manitoba Conservation and Climate Paul Bauer – Vice President & General Manager, Miller Environmental Corporation Yolo Ortiz – Operations Manager, Miller Environmental Corporation Appendix A

Leachate Pond Stamped Construction Drawings

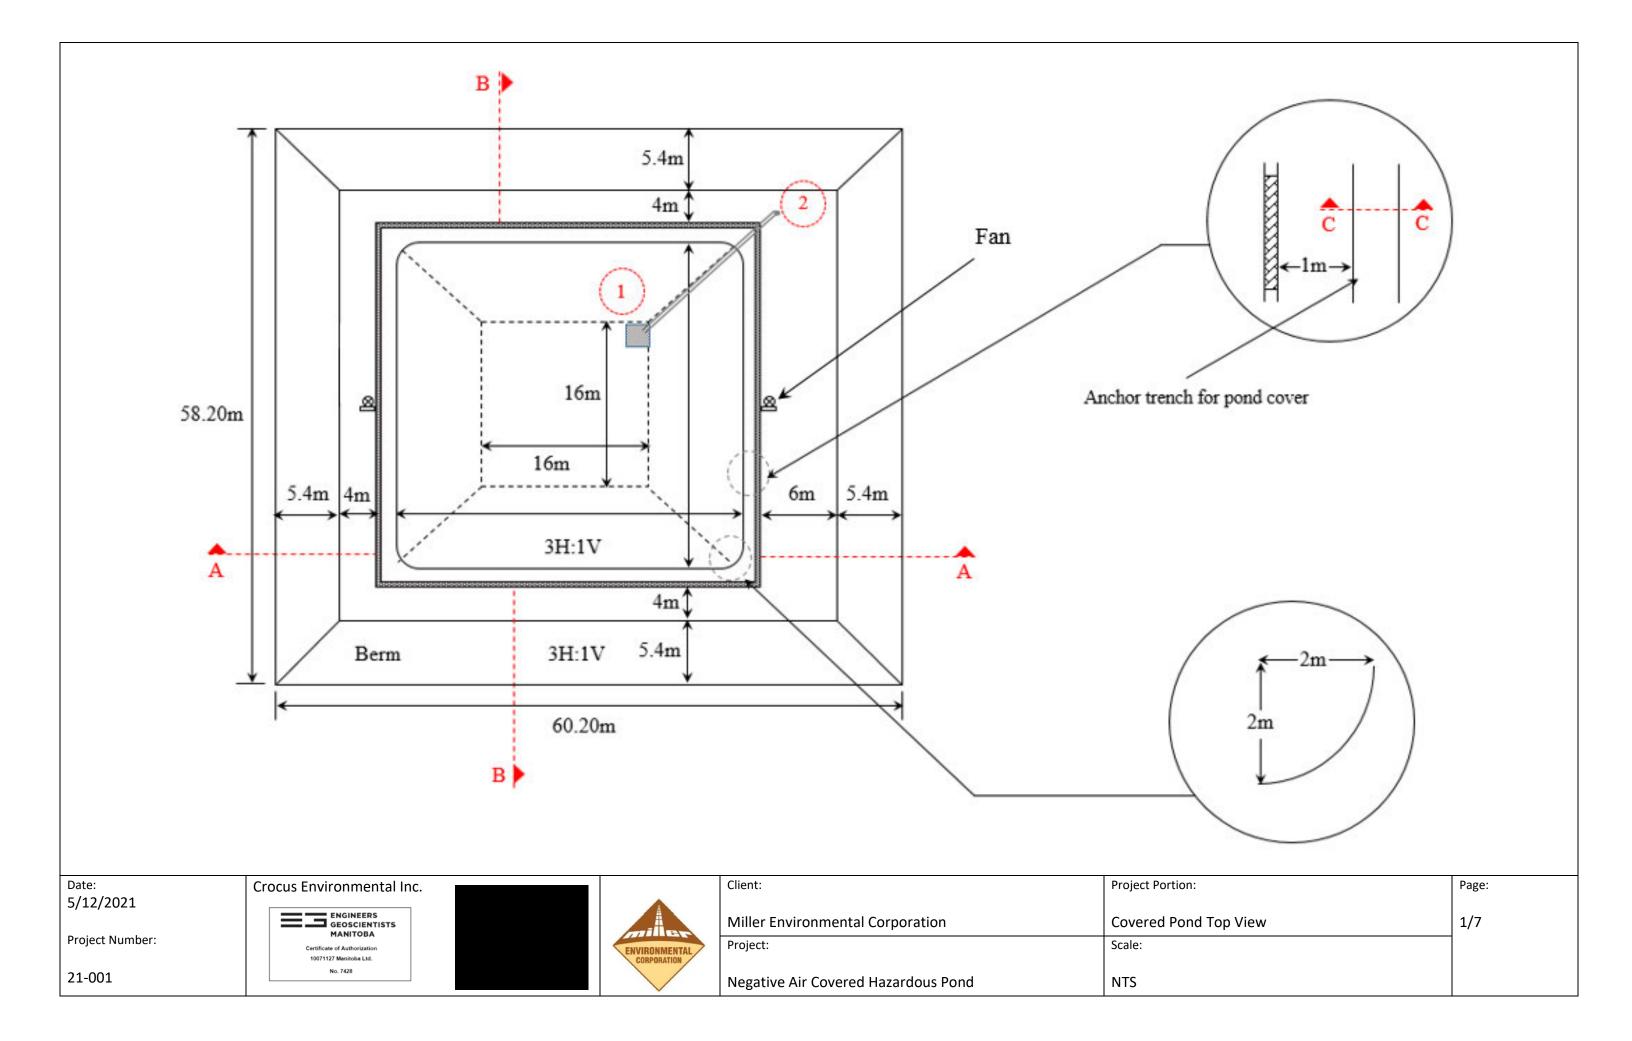


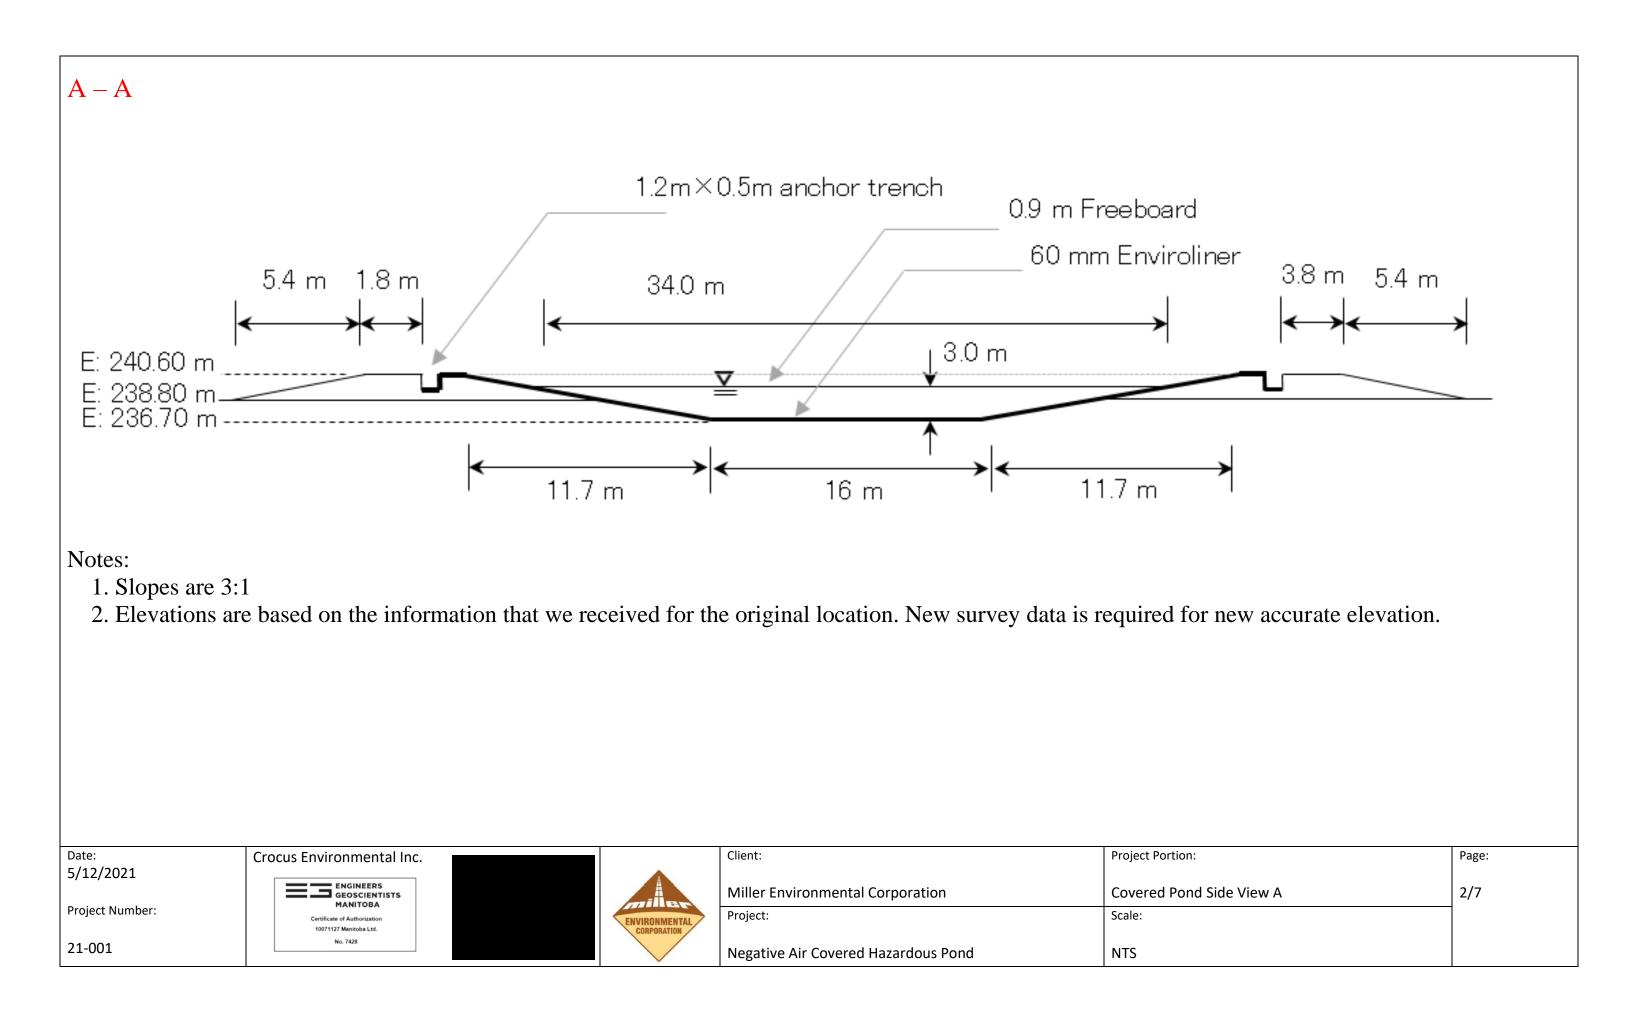

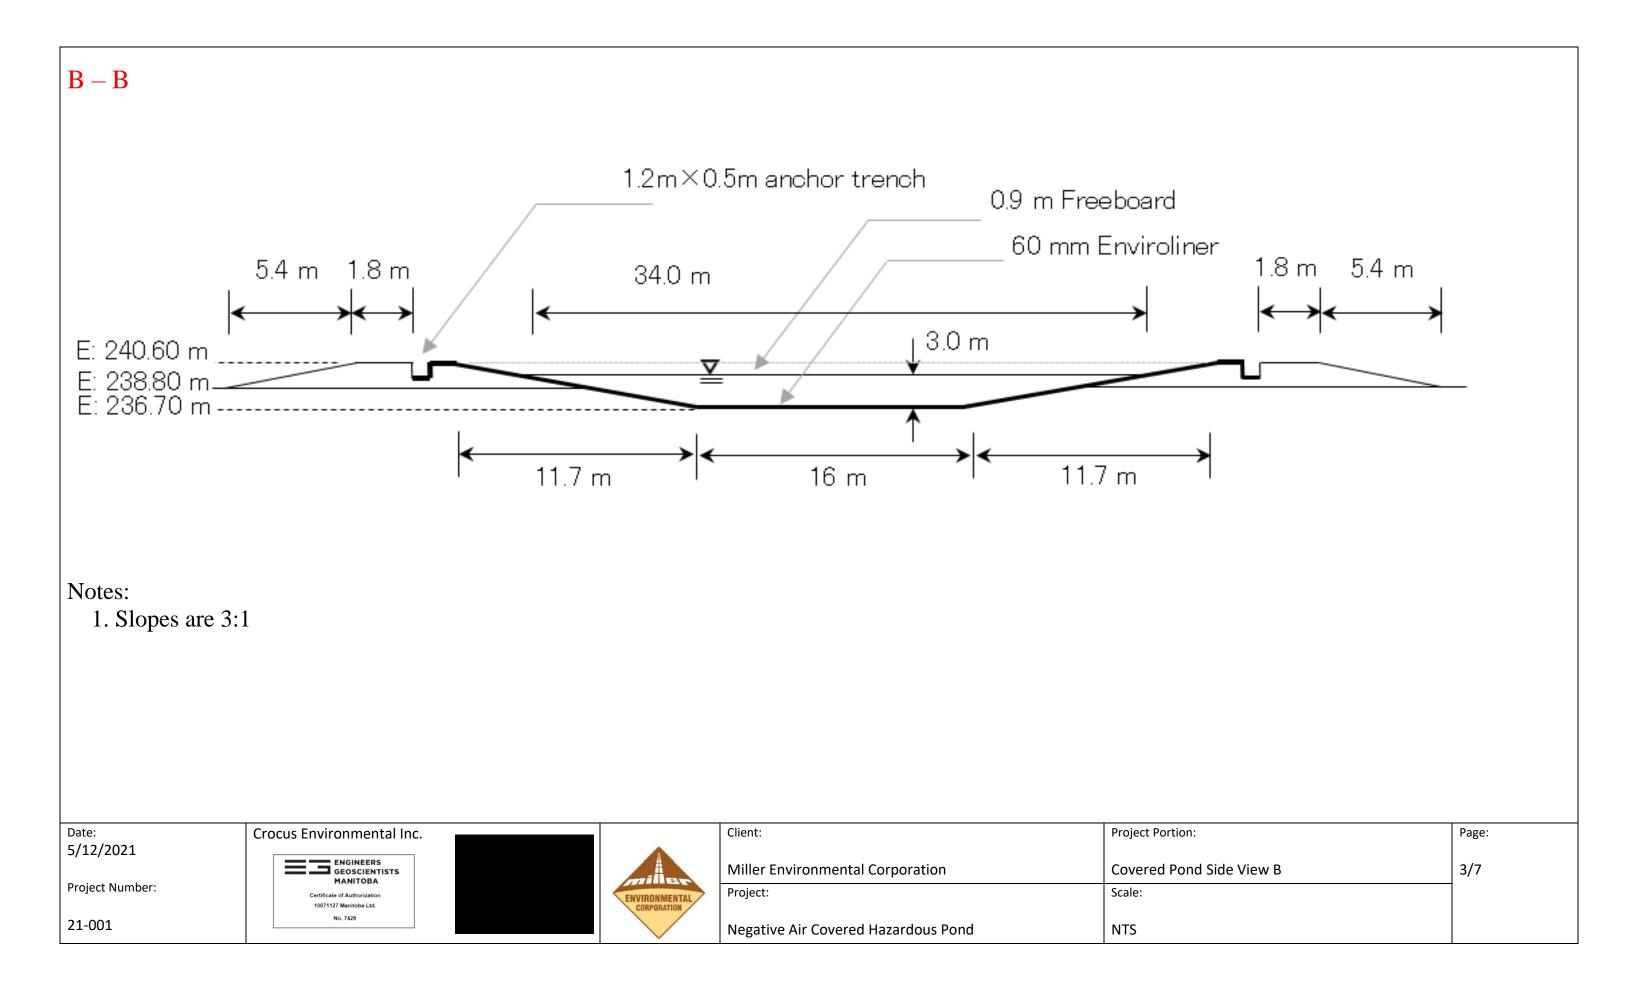

## $\mathbf{C} - \mathbf{C}$ (I)

Details of the anchor trench

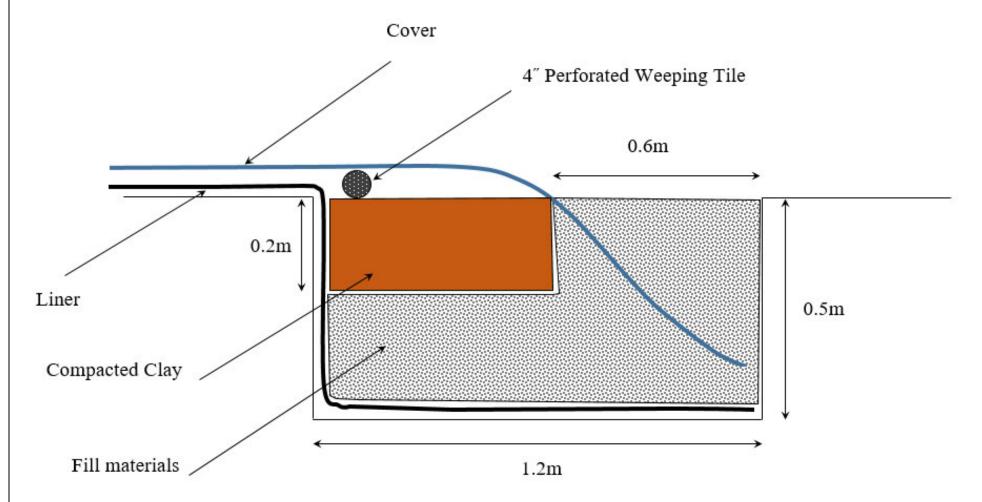

### Note:


1. On one side sand bags can be used instead of fill material to allow easy opening of the pond cover.

Date:	Crocus Environmental Inc.		Client:	Project Portion:
5/12/2021				
		miller	Miller Environmental Corporation	Cover and Liner
Project Number:	Certificate of Authorization 1007/127 Manihola Ltd.	ENVIRONMENTAL	Project:	Scale:
21-001	No. 7428	CONFORATION	Negative Air Covered Hazardous Pond	NTS


	Page:
ner Anchor Trench Details	4/7

## C - C (II)


Details of the weeping tile and connection to the fans

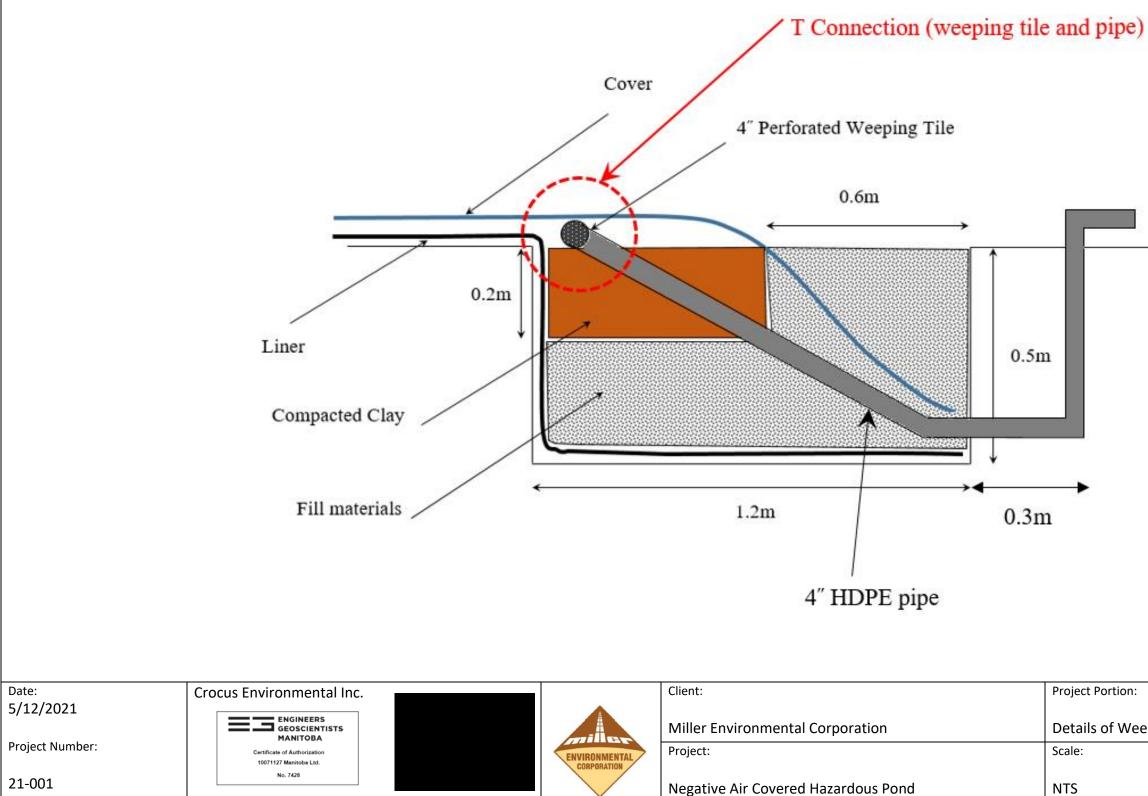

⊢⊃ "Fan"	
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Pad for the Discharge Pipe	6/7

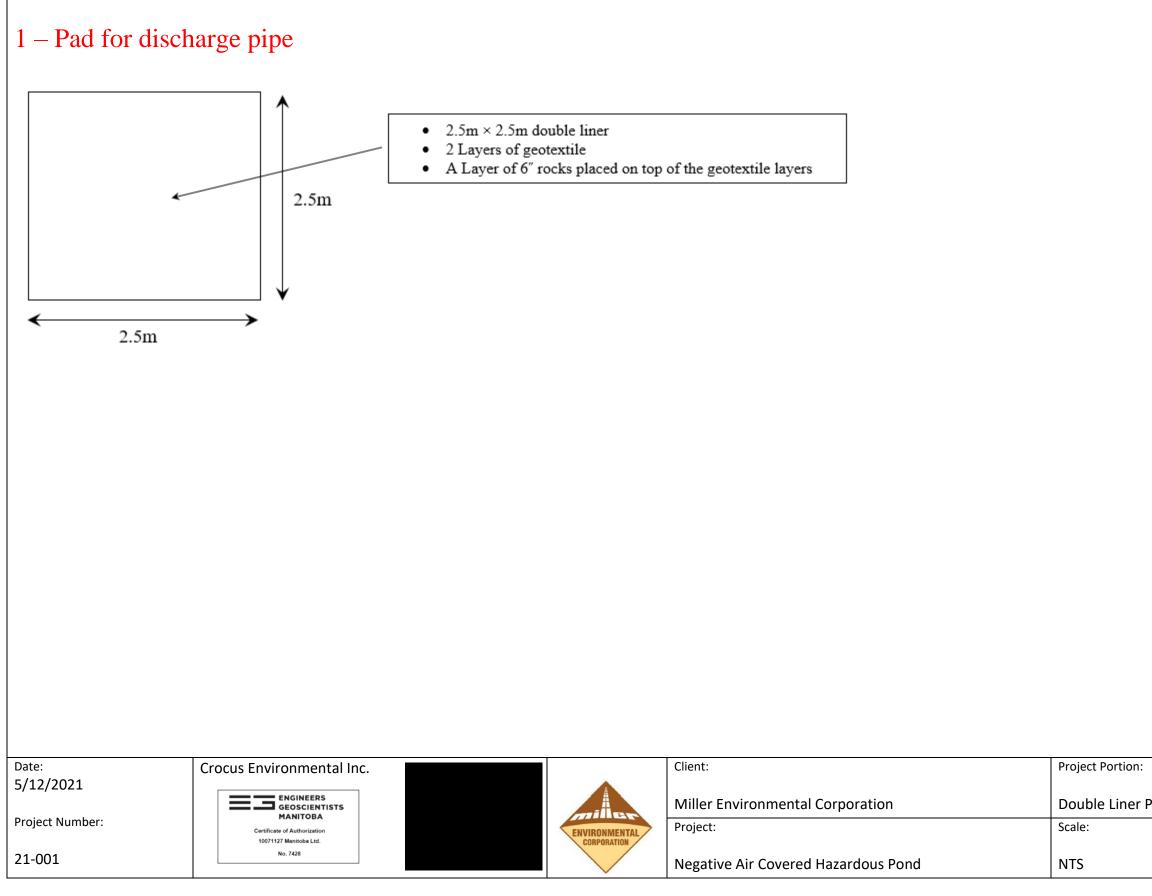

	Page:
Discharge Pipe	7/7
Discharge ripe	,,,,

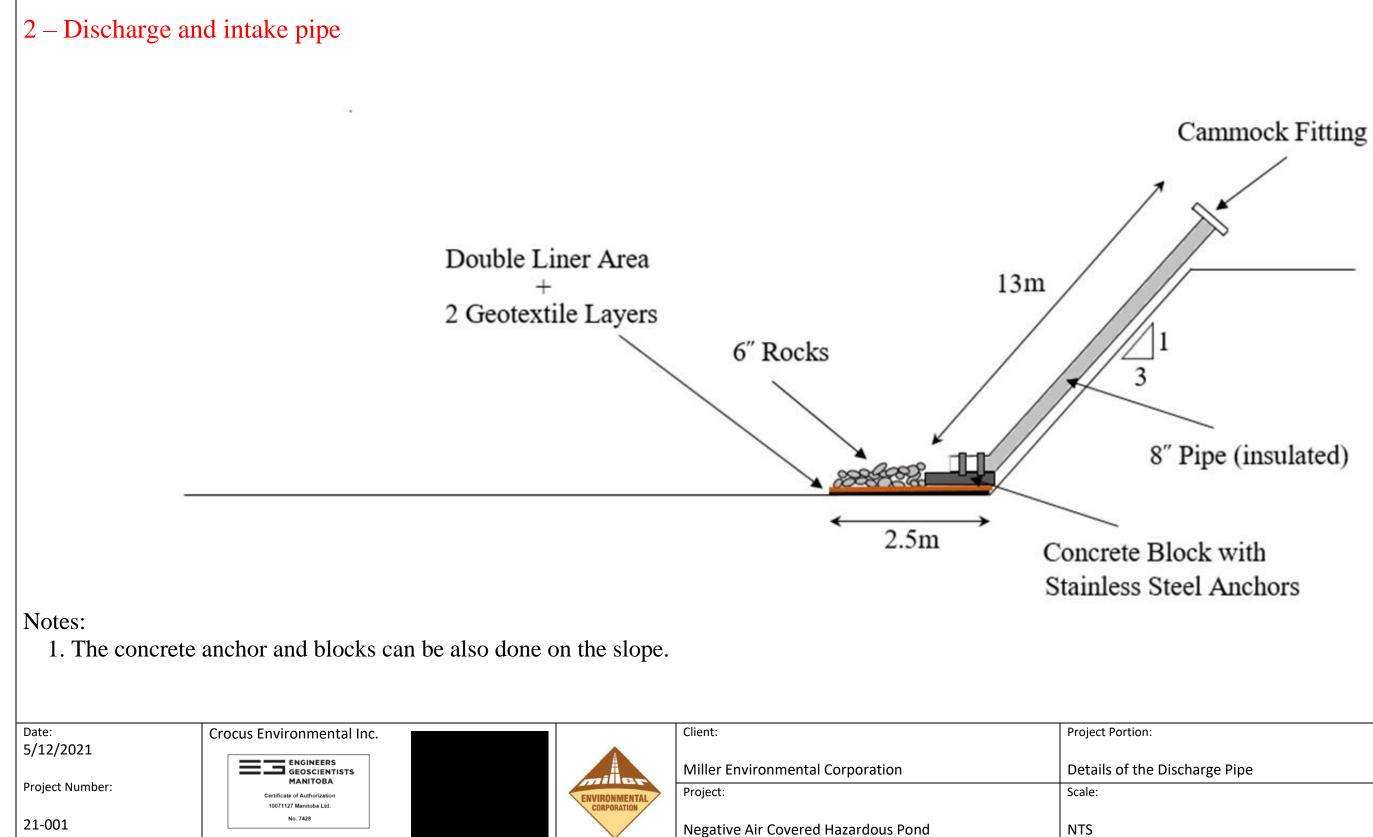Appendix B

Leachate Pond Location Details

					RC2- PHASE 2				(DISCHARG	CONCRETE MAN SE LINES RUNNIN PTAKE PIPE FOR	G TO NEV
					RC3 LEACHA	TE EVAPORATOR PIPIN			0.5 %	FAN	
		1%			RC3 LEACHATE	COLLECTION PIPE		(DI:	1	NHOLE RUNNING TO NEV	
REV. NO.	DESCRIPTION TO RE	VISION	REV. BY	DATE	1 SITE PLAN Scale: NTS				TOMER M LLER ENV RON	MENTAL CORPORATION	MEC H
							ENVIRON	MENTAL		VERED LEACHATE POND	PROJECT POR CHECKED PRO DRAWN BY

NHOLES NG TO NEW POND)

EVAPORATORS

# BACKFILLED EAST END OF FORMER STORMWATER POND

FAN POWER

MEC HAZARI	DOUS WASTE FAC						
PROJECT PORTION	PLAN M		LP 1.0				
CHECKED PROPOSAL	APPROVED PROPOSAL	CLIENT APPROVED	ENGINEER APPROVED				
DRAWN BY CB	AS NOTED	REFERENCE TO		DRG No.	1 of 8	REV.	0